# (R02) ROCKY MOUNTAIN REGION GRAND MESA, UNCOMPAHGRE AND GUNNISON NATIONAL FORESTS

DELTA COLORADO

### **NORTH DELTA STORAGE BUILDING**

ALASKA

Rigoral Headquarters


National Forests

National Headquarters

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**NATIONAL MAP** 



INDEX OF SHEETS				
SHEET	SHEET TITLE			
G-01	COVER SHEET			
C-01	EXISTING SITE PLAN			
C-02	PROPOSED BUILDING LOCATION			
C-03	PROPOSED UTILITIES PLAN			
C-04	DEMOLITION PLAN			
C-05	HYDRANT AND BOLLARD DETAILS			
C-06	UTILITIES DETAILS			
A-01 A-02	FLOOR PLAN & ELEVATIONS			
A-03 - A-05	BUILDING SECTIONS & SCHEDULES			
S-01 S-02	STRUCTURAL DETAILS			
S-03 - S-05	FOUNDATION DETAILS			
MEP-01 - MEP-03	MECHANICAL AND PLUMBING			
MEP-04 - MEP-06	ELECTRICAL			

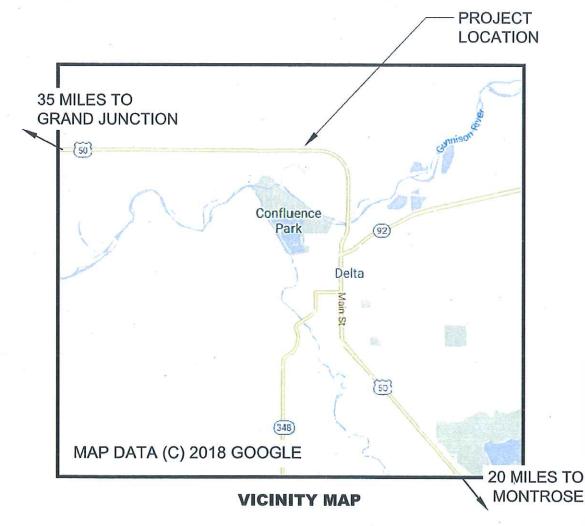REVIEWED BY:

PROJECT MANAGER

DATE

FOREST ENGINEER

6/21/19 DATE

RECOMMENDED BY:

FOREST SUPERVISOR

DATE

APPROVED BY:

REGIONAL DIRECTOR OF ENGINEERING


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SHEET 1

OF 23

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**PROJECT** 



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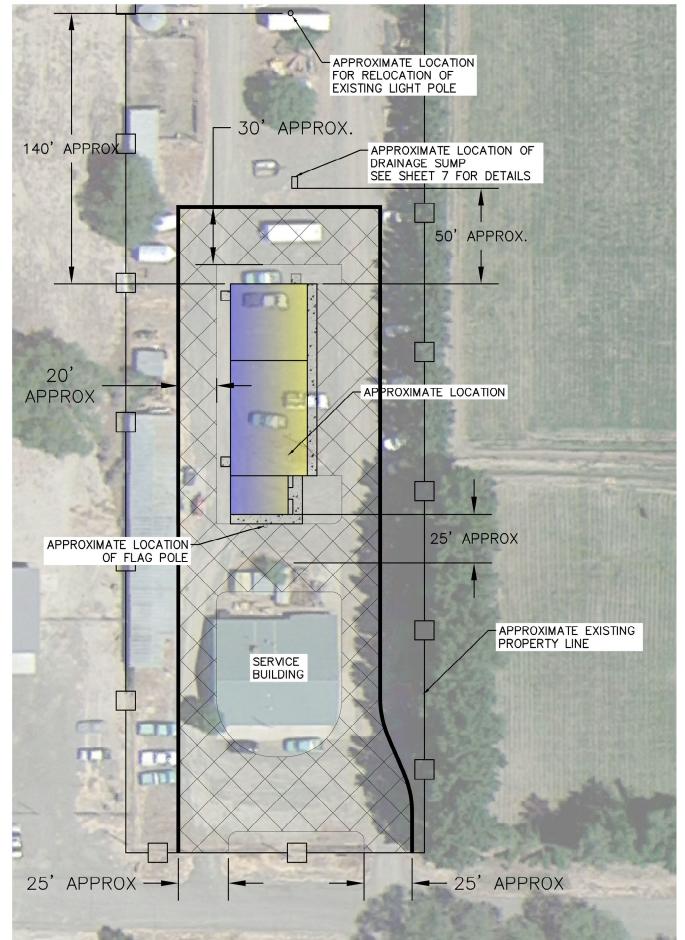
### NOTES:

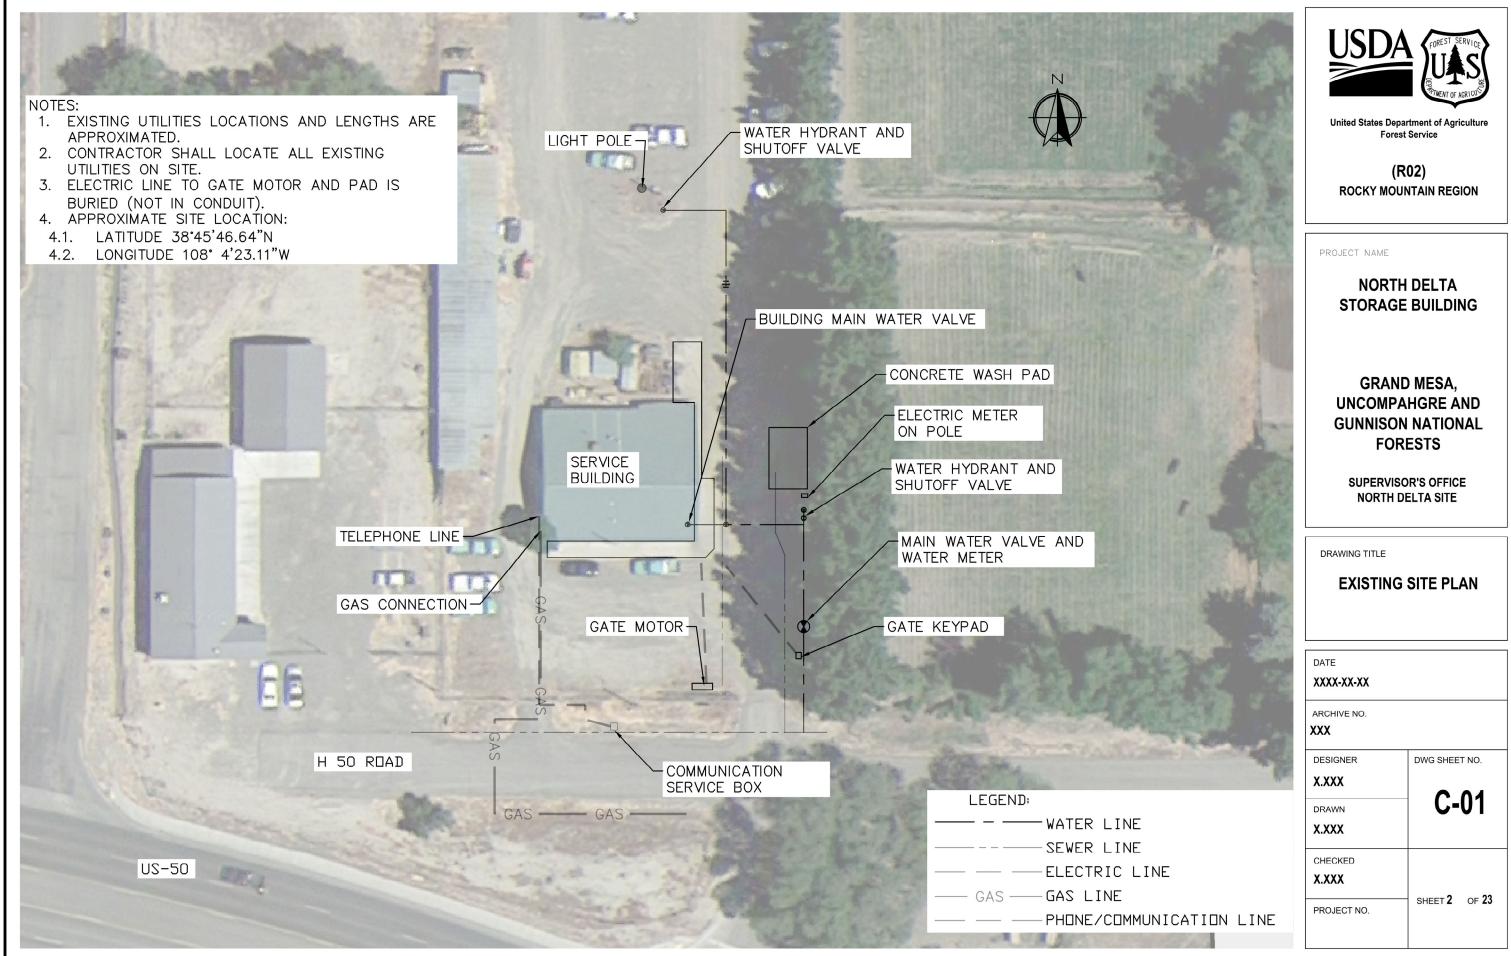- 1. SITE CHARACTERISTIC:
- 1.1. THE SITE IS APPROXIMATELY 2.6 ACRES.
- 1.2. THE EXISTING FENCE IS LOCATED APPROXIMATELY OVER THE PROPERTY LINE.
- 1.3. THE GROUND HAS MINIMAL GRADE CHANGES (MOSTLY FLAT).
- 2. CONTRACTOR SHALL STAKE APPROXIMATE BUILDING LOCATION. FINAL BUILDING LOCATION SHALL BE APPROVED BY CONTRACTING OFFICER.
- 3. CONTRACTOR SHALL REMOVE AND SALVAGE THE LIGHT POLE, FLAG POLE, WATER HYDRANT AND SHUTOFF VALVE. ITEMS SHALL BE STORED ON SITE.
- 4. MATERIALS AND EQUIPMENT CAN BE STORED AT SITE AS APPROVED BY CO. THE CONTRACTOR SHALL TAKE THE NECESSARY PRECAUTIONS TO PROTECT THE MATERIALS AND EQUIPMENT FROM VANDALISM.
- 5. INSTALL 4" (COMPACTED) OF CDOT CLASS 4 AGGREGATE SURFACE.



NEW 4" COMPACTED AGGREGATE SURFACE







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(R02)
ROCKY MOUNTAIN REGION

PROJECT NAME

NORTH DELTA STORAGE BUILDING

GRAND MESA, UNCOMPAHGRE AND GUNNISON NATIONAL FORESTS

SUPERVISOR'S OFFICE NORTH DELTA SITE

DRAWING TITLE

# PROPOSED BUILDING LOCATION

DATE	
XXXX-XX-XX	
ARCHIVE NO.	
XXX	
DESIGNER	DWG SHEET NO.
X.XXX	0.00
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PROJECT NO.	SHEET 3 OF 23

### NOTES

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- 1. EXISTING UTILITY LOCATIONS AND LENGTHS ARE APPROXIMATED.
- 2. CONTRACTOR SHALL LOCATE ALL EXISTING UTILITIES ON SITE.
- 3. EXISTING ELECTRIC LINES TO GATE MOTOR AND KEY PAD ARE BURIED (NOT IN CONDUIT).
- 4. NEW UTILITY LINES LOCATIONS SHALL BE STAKED IN THE FIELD BY CONTRACTOR AND APPROVED BY CO.
- 5. APPROXIMATE SITE LOCATION:
- 5.1. LATITUDE 38°45'46.64"N
- 5.2. LONGITUDE 108° 4'23.11"W

### KEY NOTES

- 1. RE-LOCATE EXISTING LIGHT POLE TO 140' NORTH OF NEW BUILDING.
- 2. NEW ELECTRIC LINE FROM BUILDING TO LIGHT POLE.
- 3. NEW HYDRANT.
- 4. NEW 3/4" WATER LINE TO HYDRANT.
- 5. BUILDINGS TO BE DECOMMISSIONED.
- 6. NEW BUILDING.
- 7. NEW ELECTRIC LINE FROM EXISTING ELECTRIC METER.
- 8. NEW COMMUNICATIONS CONDUIT WITH PULL WIRES TO BUILDING.
- 9. NEW 4" SEWER LINE TO BUILDING.
- 10. NEW 1" WATER LINE.
- 11. NEW SEWER LINE CONNECTION WITH EXISTING SEWER LINE.
- 12. EXISTING WASH PAD DO NOT DISTURB.
- 13. EXISTING POWER POLE WITH ELECTRIC METER DO NOT DISTURB.
- 14. NEW WATER LINE CONNECTION WITH EXISTING WATER LINE.
- 15. EXISTING WATER METER AND WATER MAIN VALVE.
- 16. EXISTING GATE MOTOR AND CARD READERS.
- 17. EXISTING COMMUNICATION BOX.
- 18. NEW 3/4" GAS LINE.
- 19. NEW ELECTRIC CONDUIT FROM BUILDING TO ELECTRIC GATE AND CARD READERS.
- 20. EXISTING FLAG POLE TO BE SALVAGE AND RELOCATED.



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NORTH DELTA STORAGE BUILDING


GRAND MESA, UNCOMPAHGRE AND GUNNISON NATIONAL FORESTS

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DRAWING TITLE

# PROPOSED UTILITIES PLAN

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### BUILDINGS TO BE DEMOLISHED:

1. SERVICE BUILDING: 3,048 SQFT

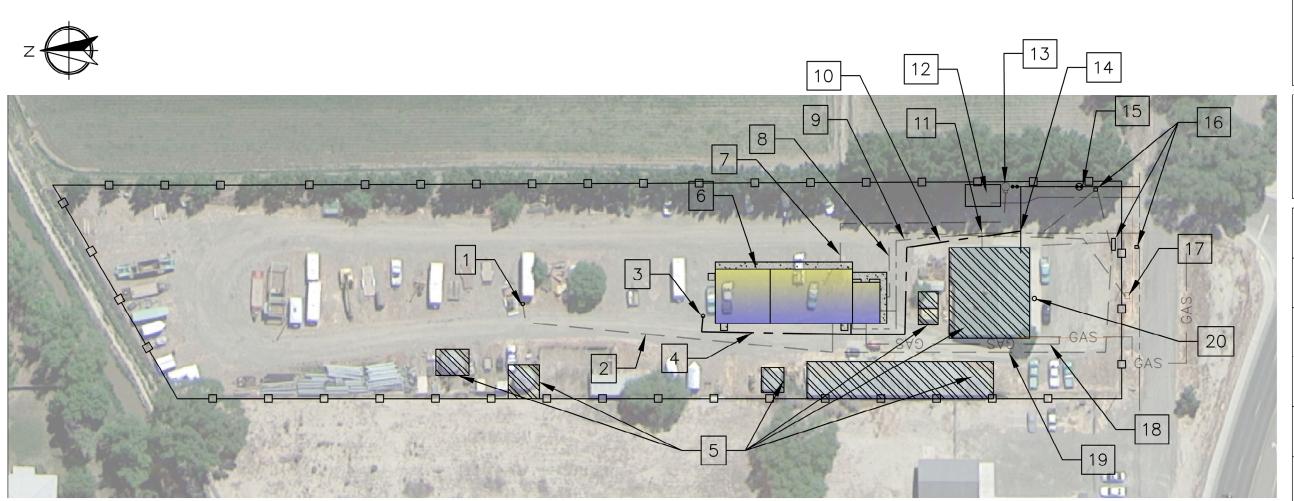

3. FLAMMABLE BUILDING: 144 SQFT.



6. SOUTH GRAIN BLDG: 161 SQFT



2. STORAGE BUILDING: 2,727 SQFT



4. SMALL STORAGE #1: 64 SQFT SMALL STORAGE #2: 70 SQFT



7. NORTH GRAIN BLDG: 183 SQFT



NOTES:

- 1. FINISH GRADE SHALL MATCH EXISTING GROUND.
- 2. ENVIRONMENTAL REPORT SHOWS THE PRESENCE OF ASBESTOS AND LEAD PAINT ON THE SITE (SEE ATTACHED REPORTS FOR SPECIFICS). ADDITIONAL INVESTIGATION MAY BE NEEDED TO PROPERLY DISPOSE BUILDINGS.
- 3. ASBESTOS SHALL BE REMOVED AND DISPOSED OF IN ACCORDANCE WITH REGULATIONS BY A CERTIFIED CONTRACTOR.
- 4. THE CONTRACTOR SHALL PROVIDE ASBESTOS REMOVAL PLAN.
- 5. THE CONTRACTOR SHALL REMOVE ALL CONSTRUCTION DEBRIS AND PROPERLY DISPOSE OUTSIDE FOREST SERVICE PROPERTY.
- 6. THE FOREST WILL REMOVE/RELOCATE FROM BUILDINGS ANY MATERIAL/EQUIPMENT TO REMAIN AS FOREST PROPERTY.



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PROJECT NAME

NORTH DELTA STORAGE BUILDING


**GRAND MESA, UNCOMPAHGRE AND GUNNISON NATIONAL FORESTS** 


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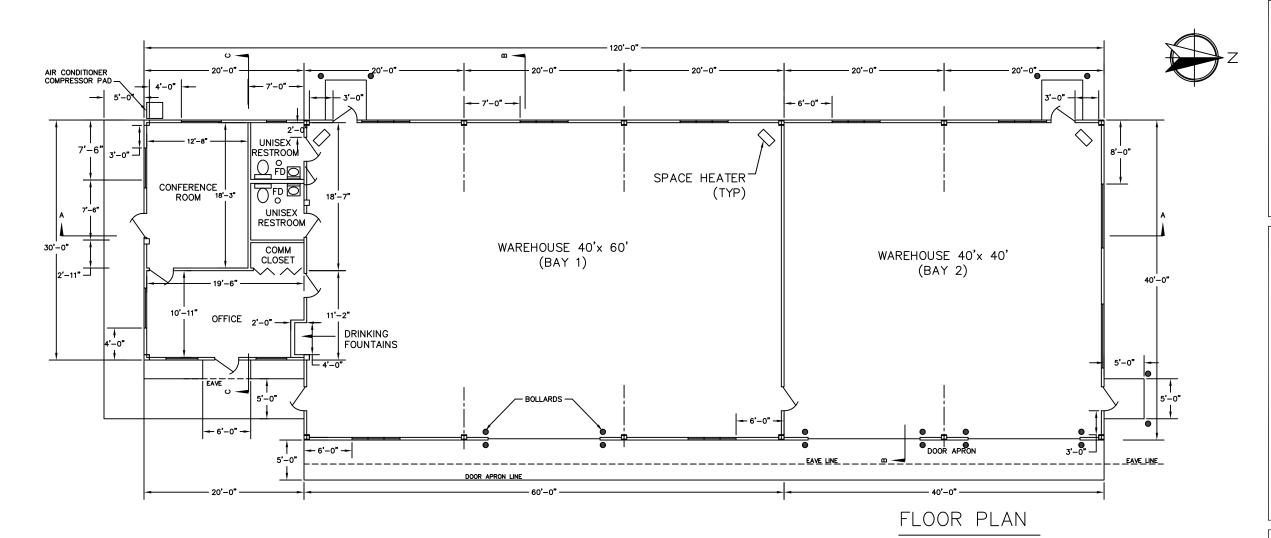
DEMOLITION PLAN (OPTIONAL BID ITEM)


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NOTES:

- 1. CONTRACTOR SHALL SUBMIT BUILDING SPECIFICATIONS AND RECEIVE WRITTEN APPROVAL FROM CONTRACTING OFFICER BEFORE ORDERING BUILDING MATERIALS.
- 2. EXIT DOORS AT BAY 1 AND 2 CAN BE RELOCATED PER MANUFACTURERS RECOMMENDATION. FINAL LOCATION OF EXIT DOORS SHALL BE APPROVED BY CONTRACTING OFFICER.
- 3. SKYLIGHTS SHALL BE DYNAMIC DOME WITH IMPACT MODIFIED ACRYLIC BY VELUX OR
- APPROVED EQUAL. SKYLIGHT DIMENSION 4'x8'.

4. EXHAUST PIPES NOT SHOWN FOR CLARITY.

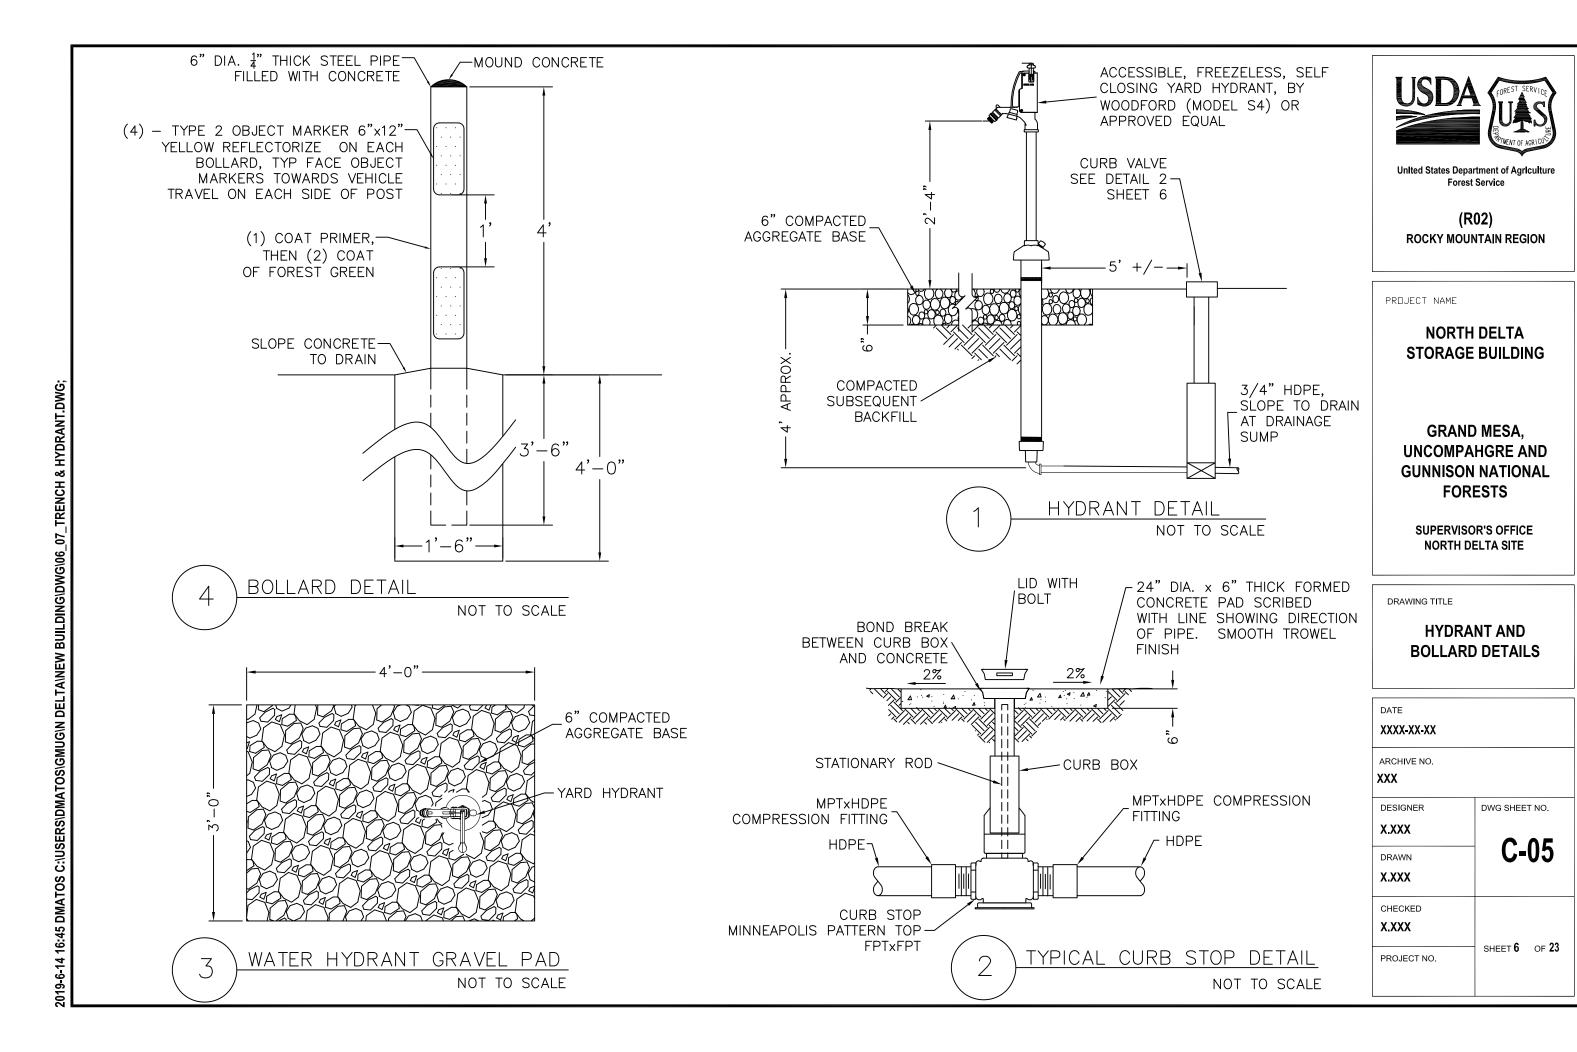WEST ELEVATION

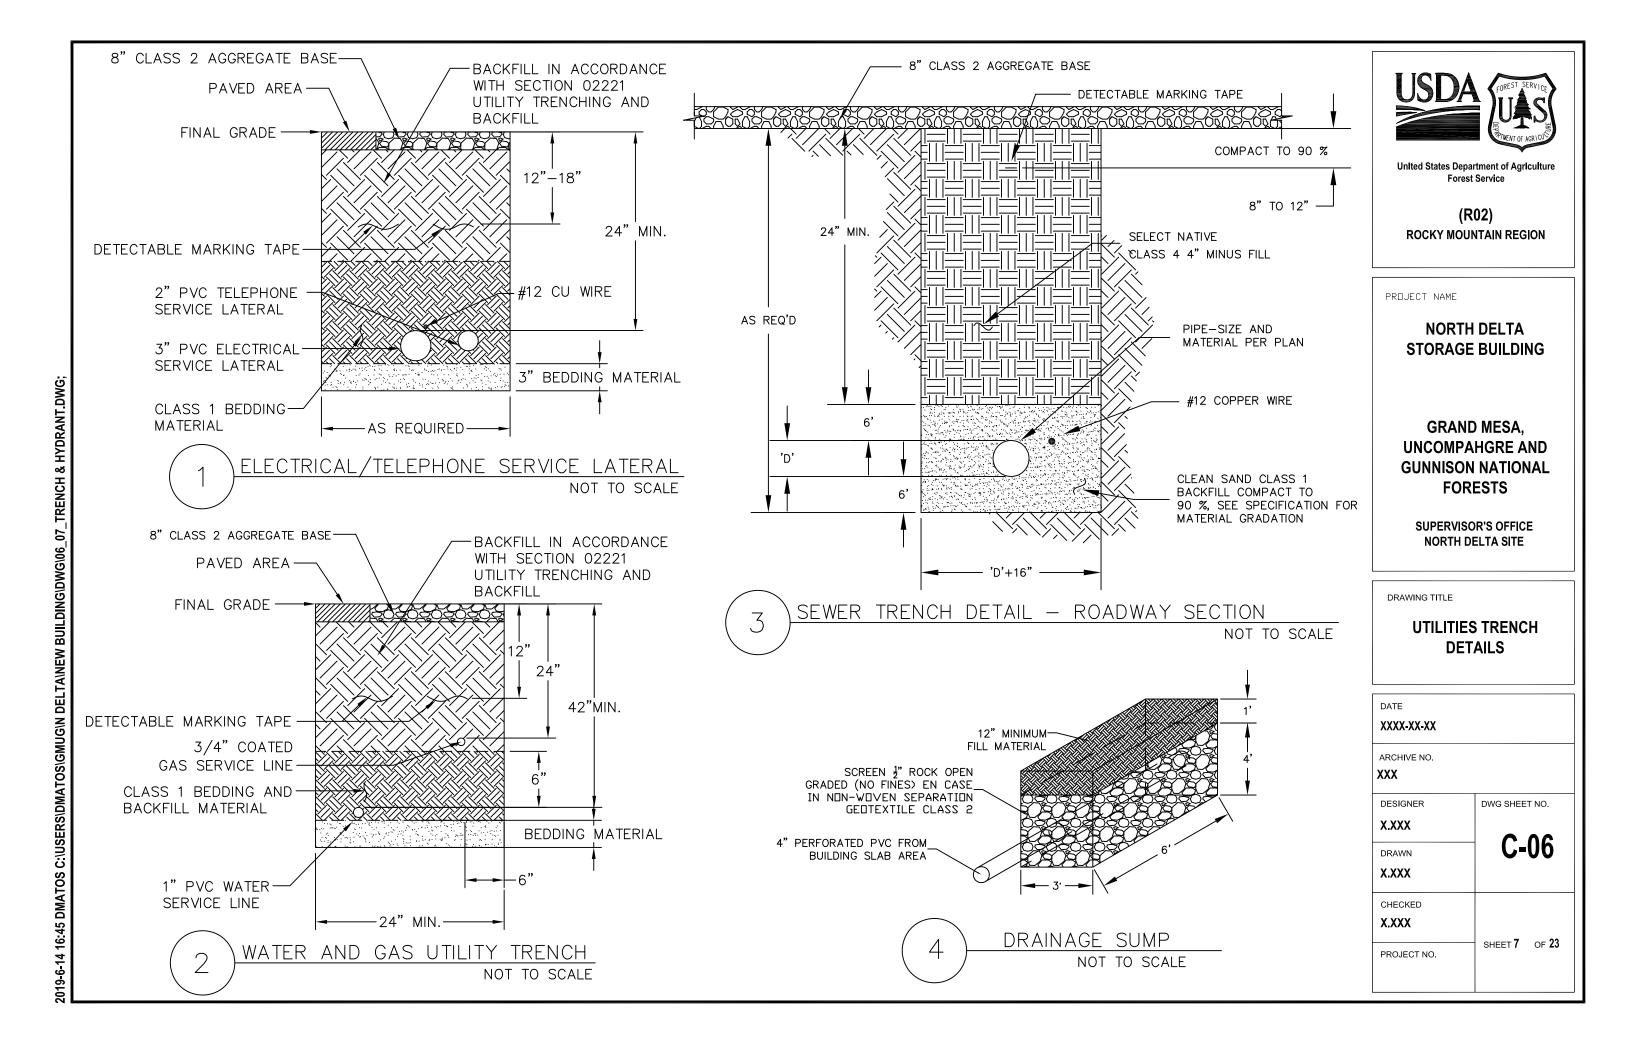

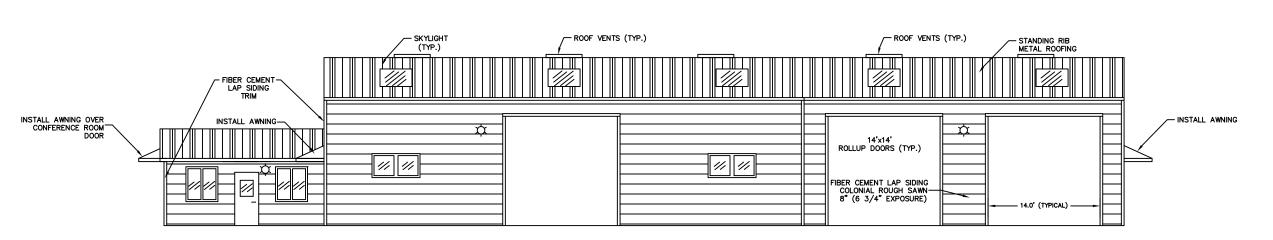

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(R02)
ROCKY MOUNTAIN REGION

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NORTH DELTA STORAGE BUILDING


GRAND MESA, UNCOMPAHGRE AND GUNNISON NATIONAL FORESTS


SUPERVISOR'S OFFICE NORTH DELTA SITE

DRAWING TITLE

FLOOR PLAN & ELEVATION

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DESIGN CRITERIA - INTERNATIONAL BUILDING CODE 2018

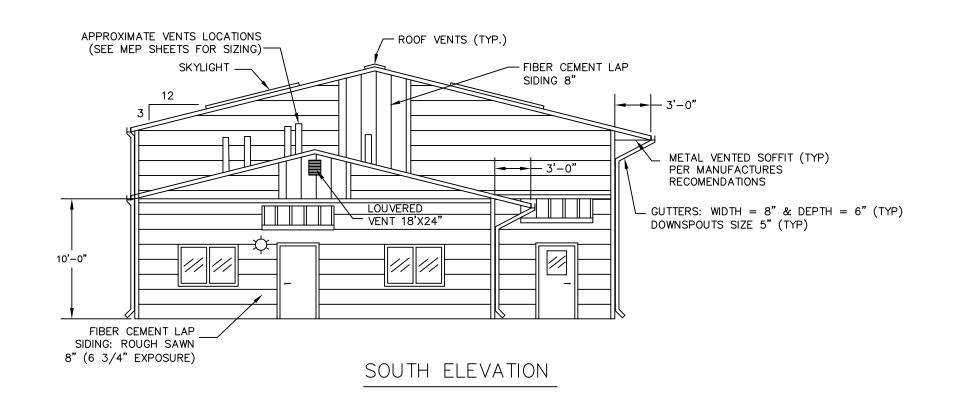SNOW LOAD \_\_ \_ \_ 30 POUNDS PER SQUARE FOOT WIND LOAD \_\_ \_ 90 MILES PER HOUR, EXPOSURE C SEISMIC DESIGN CATEGORY C

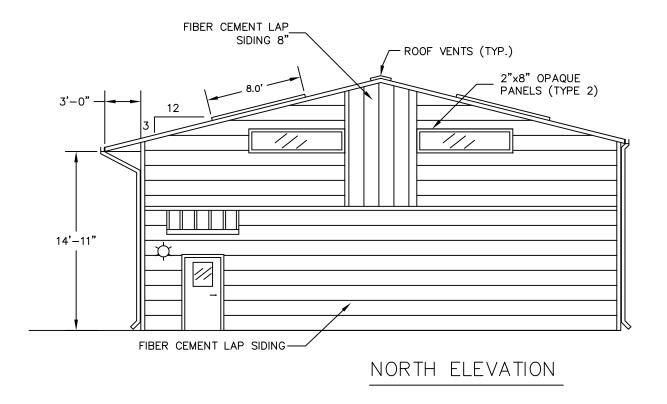



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(R02)
ROCKY MOUNTAIN REGION

PROJECT NAME

NORTH DELTA STORAGE BUILDING


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DRAWING TITLE

### **BUILDING ELEVATION**

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PROJECT NO.	SHEET 9 OF 23



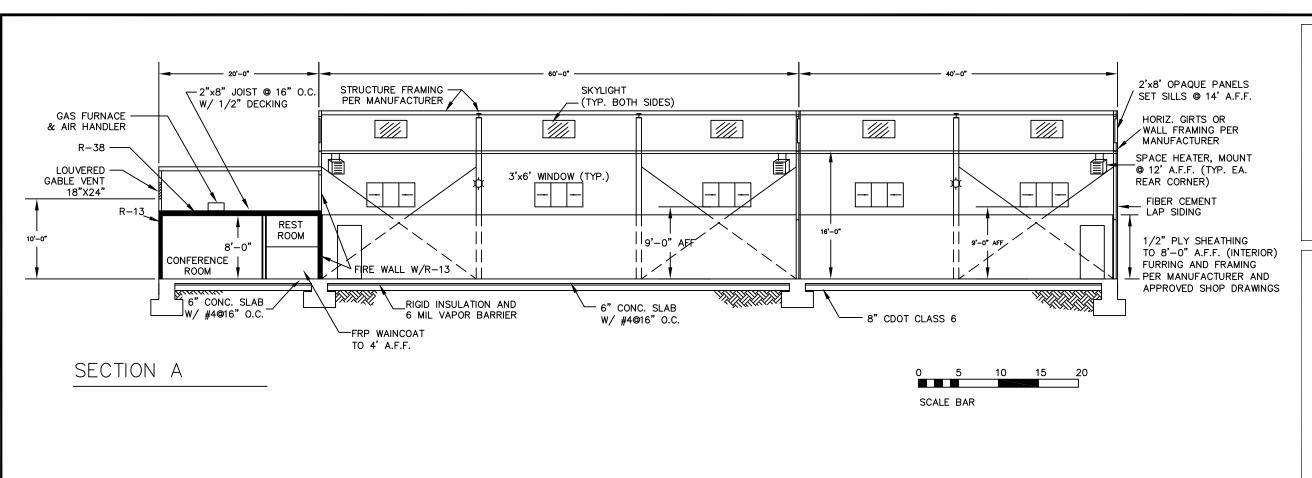

(R02) **ROCKY MOUNTAIN REGION** 

PROJECT NAME

### **NORTH DELTA STORAGE BUILDING**


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SUPERVISOR'S OFFICE **NORTH DELTA SITE** 

DRAWING TITLE


### **BUILDING SECTION AND BATHROOM** LAYOUT

DATE XXXX-XX-XX	
ARCHIVE NO.	
XXX	
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PROJECT NO.	SHEET 10 OF 23

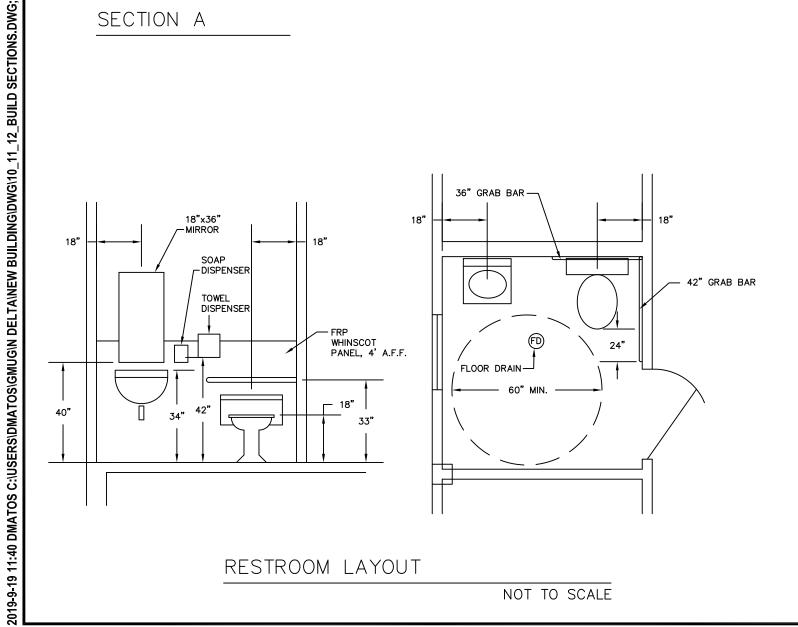

RESTROOM LAYOUT

NOT TO SCALE

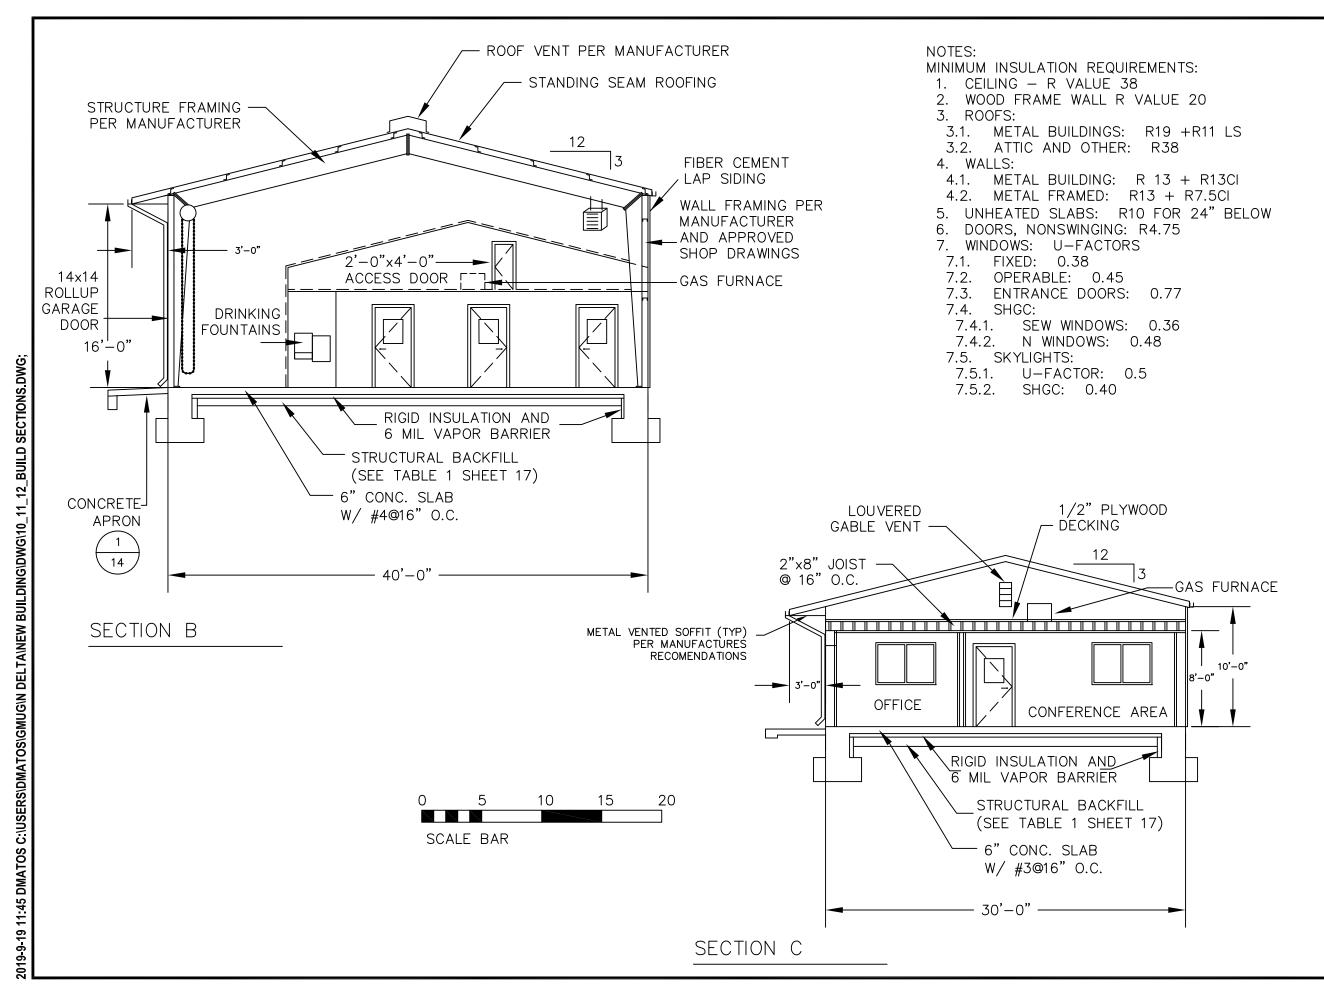



(R02)
ROCKY MOUNTAIN REGION

PROJECT NAME

## NORTH DELTA STORAGE BUILDING


### GRAND MESA, UNCOMPAHGRE AND GUNNISON NATIONAL FORESTS

SUPERVISOR'S OFFICE NORTH DELTA SITE

DRAWING TITLE

### **BUILDING SECTIONS**

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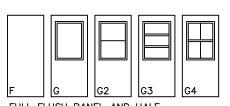


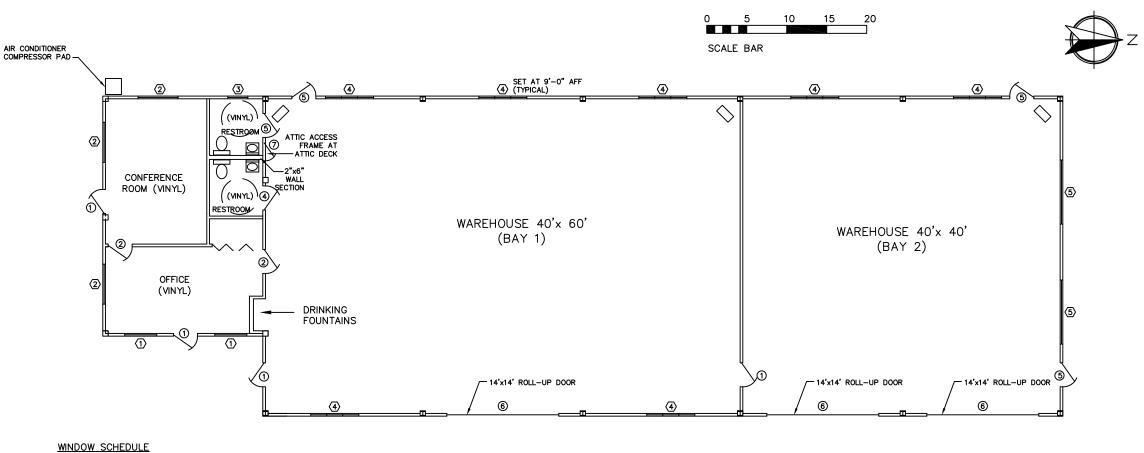SYMBOL	SIZE	MATERIAL	GLAZING	TYPE	REMARKS
1	4'-0"x4'-0"	VINYL	CLEAR	1	OFFICE WINDOW
2	4'-0"x5'-0"	VINYL	CLEAR	1	OFFICE WINDOW
3	2'-0"x2'-0"	VINYL	OBSCURE	1	RESTROOM WINDOW
4	3'-0"x6'-0"	VINYL	CLEAR	1A	WAREHOUSE SILL @ 9'-0" A.F.F.
(5)	2'-0"x8'-0"	VINYL	OPAQUE	2	WAREHOUSE SILL @ 14'-0" A.F.F.


### DOOR SCHEDULE

SYMBOL	FACING	TYPE	GLASS	SIZE	REMARK
①	STEEL	G	SAFETY	3'-0"x6'-8"x1 3/4"	EXTERIOR ENTRANCE
2	STEEL	N-4	SAFETY	3'-0"x6'-8"x1 3/4"	FIRE RATED PASSAGE
3	STEEL	N-4	SAFETY	3'-0"x6'-8"x1 3/4"	FIRE RATED PASSAGE
4	STEEL	F	_	3'-0"x6'-8"x1 3/4"	EXTERIOR PASSAGE
(5)	STEEL	F	_	3'-0"x6'-8"x1 3/4"	EXTERIOR ENTRANCE
6	STEEL	_	_	14'-0"x14'-0"	OVERHEAD COILING
7	STEEL	F	-	2'-0"x4'-0"	ATTIC ACCESS FIRE RATED


### DOOR TYPES





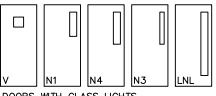

DOORS WITH GLASS LIGHTS

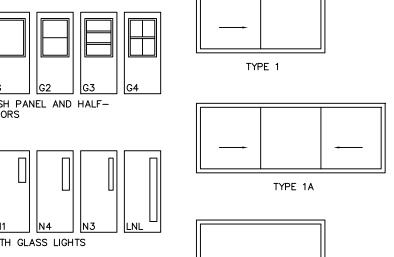

TYPE 2

WINDOW TYPES

### NOTES:

- 1. EXIT DOORS AT BAY 1 AND 2 CAN BE RELOCATED PER MANUFACTURERS RECOMMENDATION. FINAL LOCATION OF EXIT DOORS SHALL BE APPROVED BY CONTRACTING OFFICER.
- 2. EXTERIOR DOOR HANDLES SHALL BE ADA APPROVE AND PUSH BARS FROM THE INTERIOR.
- 3. FIRE RATED DOORS SHALL HAVE AUTOMATIC CLOSURES.

--- OPENING/SLIDE DIRECTION

NOT TO SCALE

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(R02) **ROCKY MOUNTAIN REGION** 

PROJECT NAME

### **NORTH DELTA** STORAGE BUILDING


### **GRAND MESA, UNCOMPAHGRE AND GUNNISON NATIONAL FORESTS**

SUPERVISOR'S OFFICE **NORTH DELTA SITE** 


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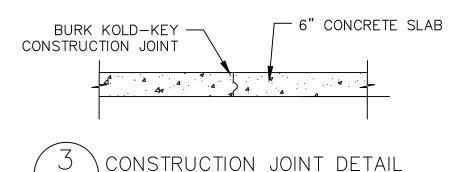
### **DOOR AND WINDOW SCHEDULE**

DATE	
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ARCHIVE NO.	
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DESIGNER	DWG SHEET NO.
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PROJECT NO.	SHEET 12 OF 23

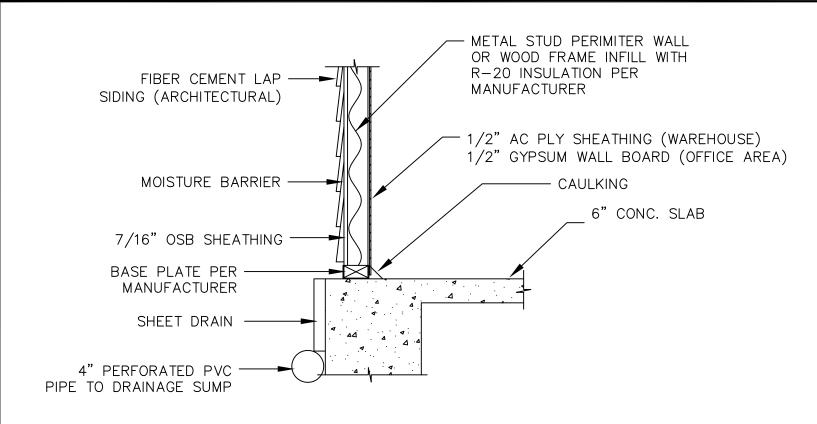

1 TYPICAL WALL SECTION - EXTERIOR 13



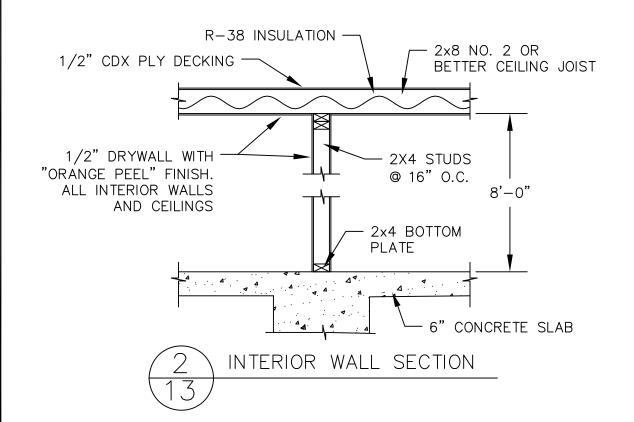

0" 1" 2" 3" 4" 5"

SCALE BAR



(R02)
ROCKY MOUNTAIN REGION

PROJECT NAME


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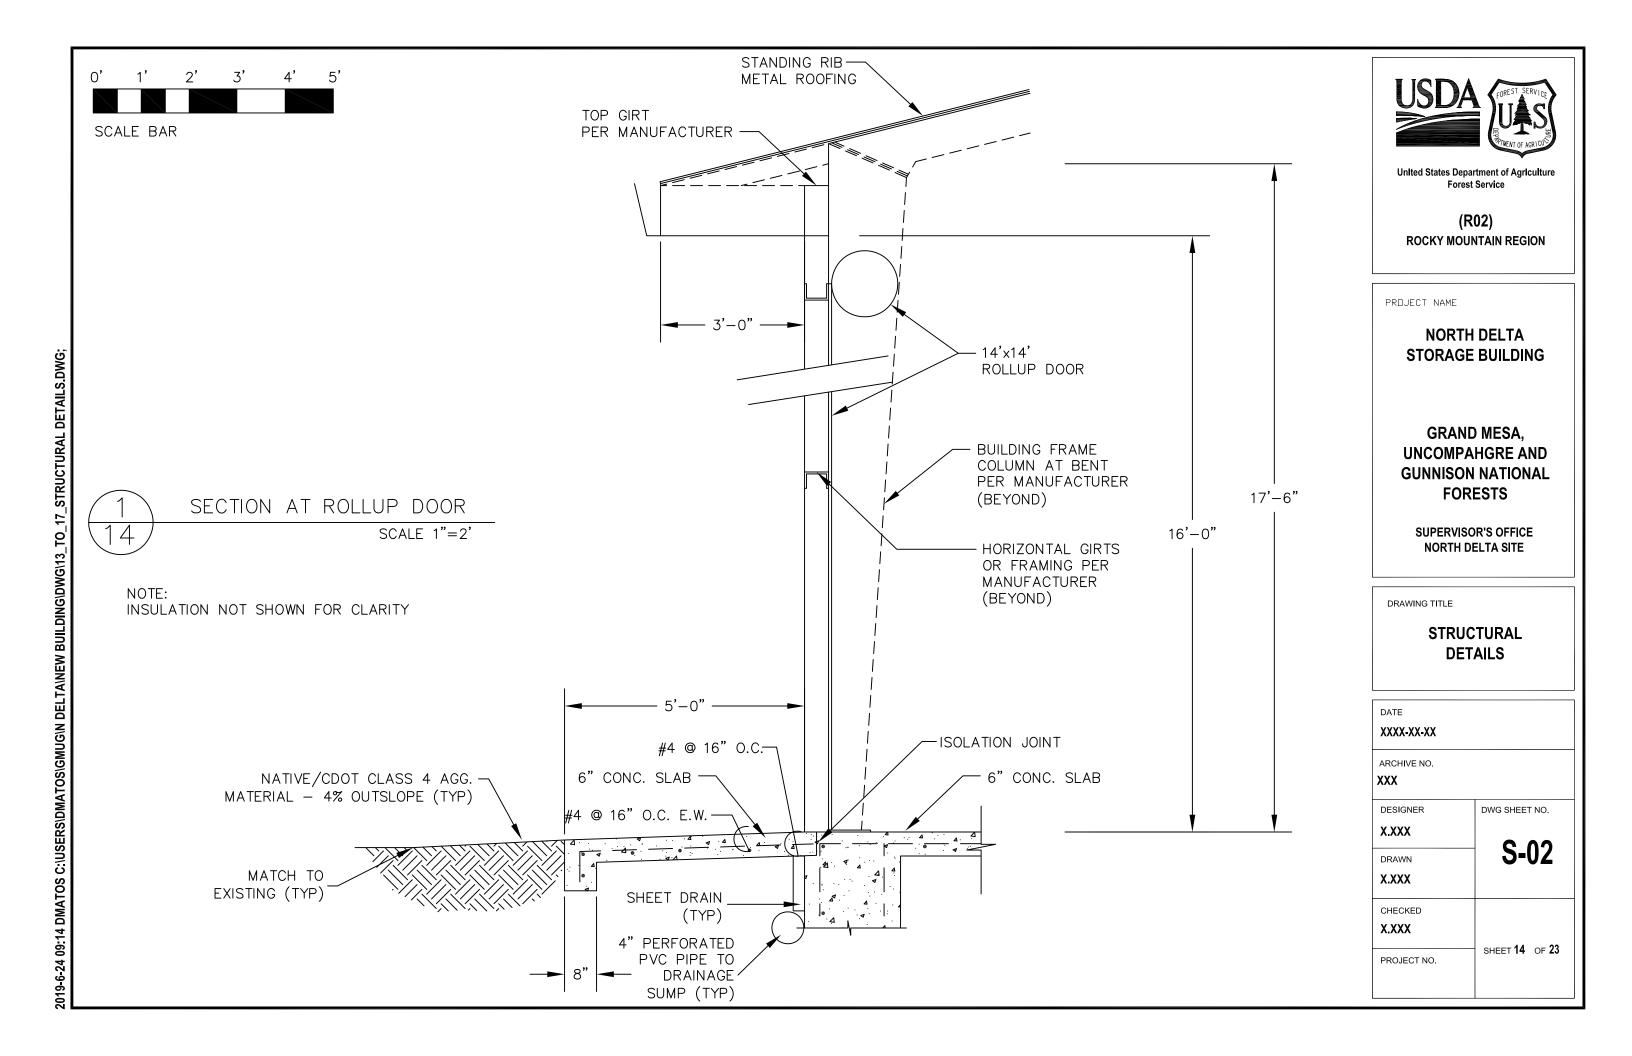
GRAND MESA, UNCOMPAHGRE AND GUNNISON NATIONAL FORESTS

SUPERVISOR'S OFFICE NORTH DELTA SITE


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# STRUCTURAL DETAILS



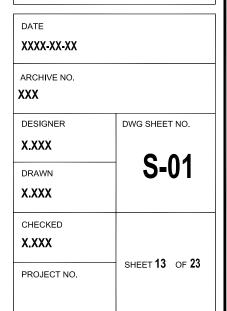

NOTE SIDEWALK TO BE BUILT AS DOOR APRON.

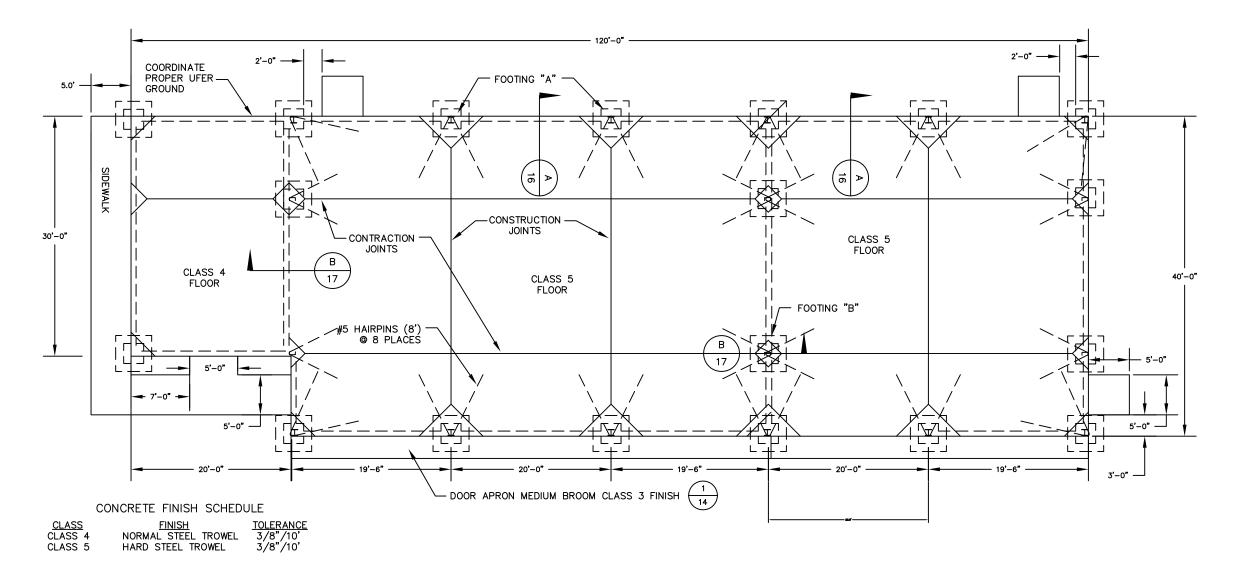

FOUNDATION PLAN

SCALE 1/8"=1'-0"

0' 5' 10' 15' 20'

SCALE BAR



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(R02)
ROCKY MOUNTAIN REGION

PROJECT NAME

### NORTH DELTA STORAGE BUILDING

### GRAND MESA, UNCOMPAHGRE AND GUNNISON NATIONAL FORESTS

SUPERVISOR'S OFFICE NORTH DELTA SITE

DRAWING TITLE

# FOUNDATION DETAILS

DATE	
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DESIGNER	DWG SHEET NO.
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PROJECT NO.	SHEET 15 OF 23
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PERIMETER WALL FRAMING



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(R02) **ROCKY MOUNTAIN REGION** 

PROJECT NAME

- 6" CONCRETE SLAB

FOOTING A SCALE 1"=2'

- 1-1/2" CLEAR

**NORTH DELTA** STORAGE BUILDING

**GRAND MESA, UNCOMPAHGRE AND GUNNISON NATIONAL FORESTS** 


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**FOUNDATION DETAILS** 

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PROJECT NO.	SHEET 16 OF 23
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Table 1 – Structural Backfill Specifications				
Graded Material Size	Percent Passing			
2-inch sieve	100			
#4 sieve 30 to 100				
#50 sieve	10 to 60			
#200 sieve 5 to 20				
Maximum Liquid Limit of 35 Maximum Plasticity Index of 6				





(R02)
ROCKY MOUNTAIN REGION
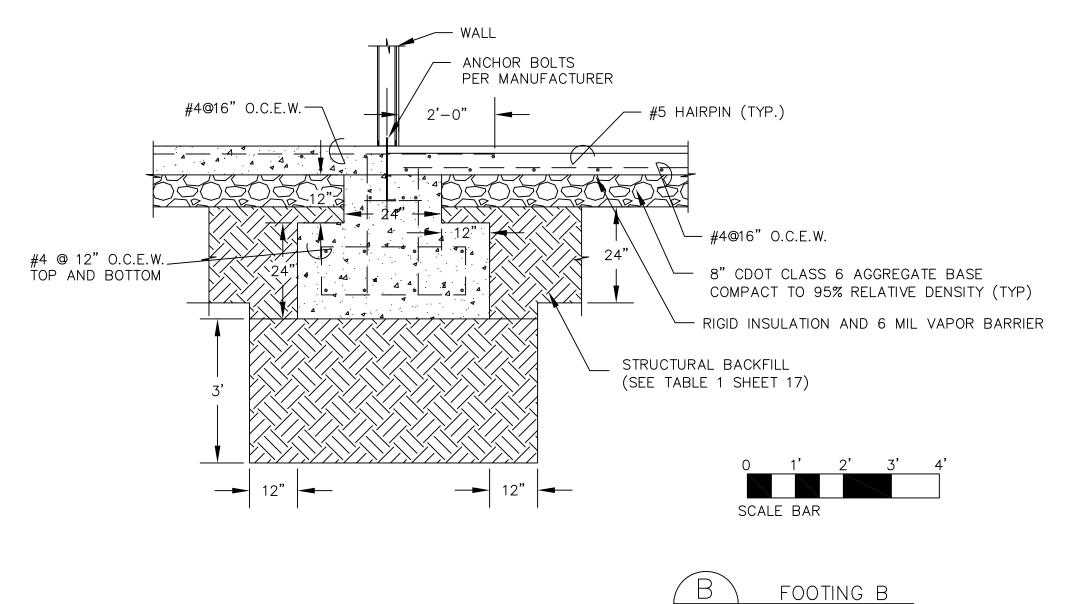
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NORTH DELTA STORAGE BUILDING

GRAND MESA, UNCOMPAHGRE AND GUNNISON NATIONAL FORESTS


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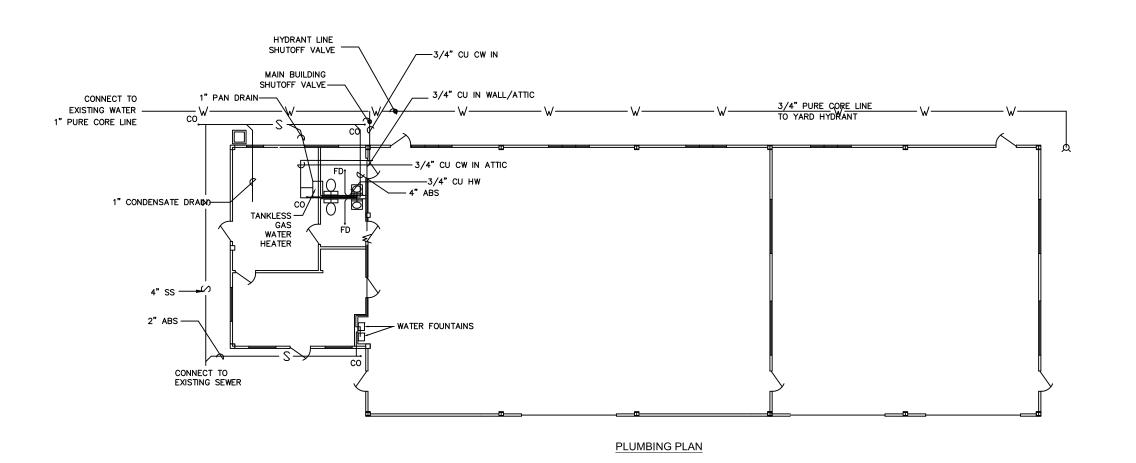
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SCALE 1"=2'

# FOUNDATION DETAILS

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PROJECT NO.	SHEET <b>17</b> OF <b>23</b>			





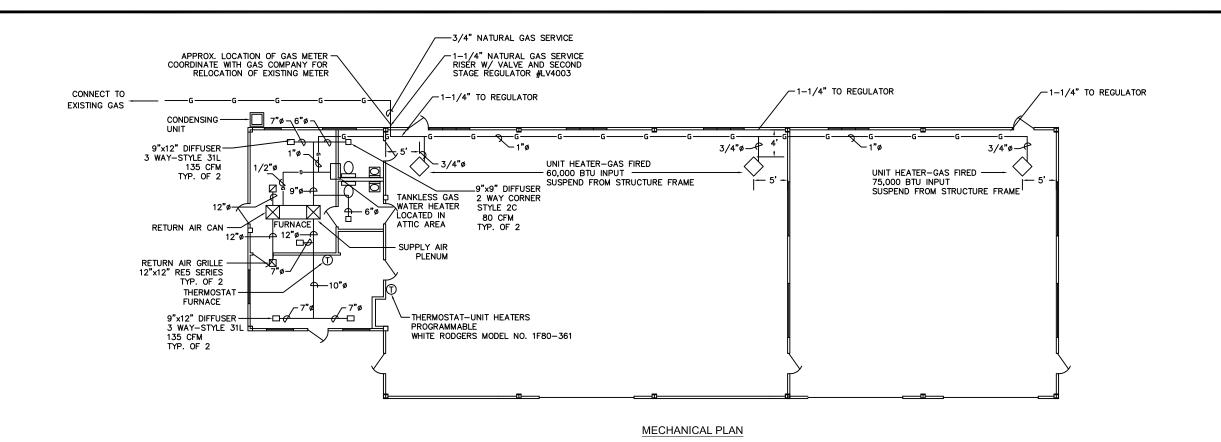

(R02)
ROCKY MOUNTAIN REGION

PROJECT NAME

NORTH DELTA
STORAGE BUILDING


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SUPERVISOR'S OFFICE NORTH DELTA SITE

DRAWING TITLE

# MECHANICAL AND PLUMBING PLAN

DWG SHEET NO.
<b>│ MEP-01</b>
SHEET 18 OF 23

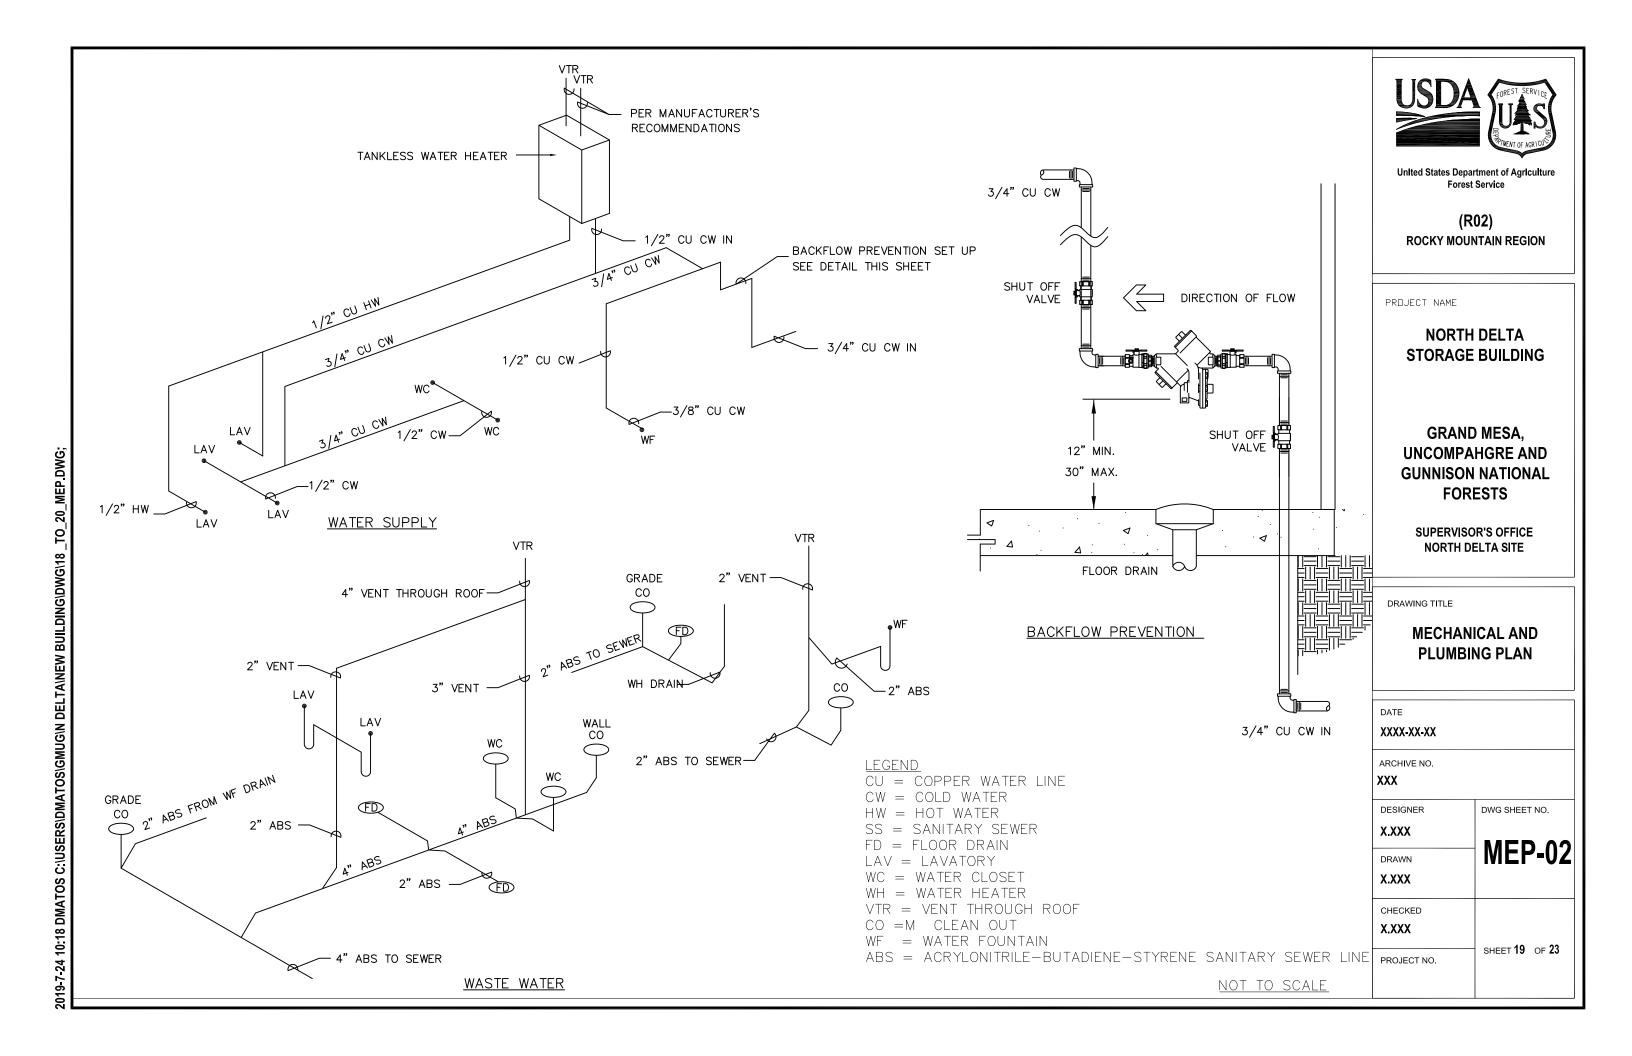

# 2019-6-24 09:25 DMATOS C:\USERS\DMATOS\GMUG\N DELTA\NEW BUILDING\DWG\18 \_TO\_20\_MEP.DWG;

### NOTES:

- 1. CONTRACTOR SHALL PROVIDE ALL EQUIPMENTS, MATERIALS AND WORKMANSHIP NECESSARY TO COMPLETE THE WORK.
- 2. DIFFUSERS: HART & COOLEY. MODELS ARE ALUMINUM CONSTRUCTION, W/ REMOVABLE CORE, FLAT MARGIN STYLE, SANT IN ANODIZED FINISH OR APPROVED EQUAL.
- 3. RETURN AIR GRILLES: HART & COOLEY RE5 SERIES OR APPROVED EQUAL.
- 4. DUCT WORK: ALL DUCT WORK SHALL BE FLEXIBLE DUCT, CLASS 1, METALIZED JACKET, HART & COOLEY F-294-R-4.2 OR APPROVED EQUAL. CONTRACTOR SHALL BE CAREFUL TO NOT KINK OR COLLAPSE FLEXIBLE DUCT.
- 5. BALANCING DAMPERS: BUTTERFLY SHALL BE MANUFACTURED PRODUCT W/ LOCKING REGULATORS FOR FLEXIBLE DUCT WORK.
- 6. ALL RECTANGULAR PLENUMS AND AIR CANS SHALL BE LINED WITH 1" THICK DUCTLINER. DUCTLINER SHALL HAVE FACTORY APPLIED ANTIMICROBIAL COATING ON THE SURFACES AND EDGES. (MANVILLE PERMACOTE LINACOUSTIC)
- 7. UNIT HEATERS: GAS (3 UNITS), DAYTON MODEL NO. 2RYV4 W/ ELECTRONIC PROGRAMMABLE THERMOSTAT, WHITE RODGERS MODEL NO. 1F80-361 OR APPROVED EQUAL.
- 8. FURNACE: RHEEM MODEL R92PA0601317MSA, MULTI-POSITION, 56,000 BTUH INPUT, 92% A.F.U.E. LP GAS FIRED OR APPROVED EQUAL.
- 9. EVAPORATOR COIL: LENNOX CH23-21 W/ COPPER TUBING, ALUMINUM FINS, STEEL CABINET OR APPROVED EQUAL.
- 10. CONDENSING UNIT: RHEEM MODEL RA1424WJ1NA, 2 TON 14 SEER, 13 EER OR APPROVED EQUAL.
- 11. THERMOSTAT: ELECTRONIC PROGRAMMABLE, SUPPLIED BY HVAC MANUFACTURER, EMERSON MODEL 1F78-144 OR APPROVED EQUAL.
- 12. VENT AND DRAINAGE PIPE SHALL BE ABS. MINIMUM VENT AND DRAIN PIPE SHALL BE 1  $\frac{1}{2}$  INCH.
- 13. VENTS FROM LAV'S AND WC'S SHALL BE CONNECTED TO A VENT SYSTEM IN THE WALL WITH ONE 4 INCH VENT THROUGH ROOF.
- 14. WATER FOUNTAINS SHALL BE ELKAY ENHANCED EZH2O BOTTLE FILLING STATION, & VERSATILE BI-LEVEL ADA COOLER, FILTERED 8 GPH LIGHT GRAY OR APPROVED EQUAL. FOLLOW MANUFACTURE'S RECOMMENDATIONS FOR WATER SUPPLY AND WASTE OUTLET LINES SIZE AND LOCATIONS; AND ELECTRICAL SUPPLY RECEPTACLES LOCATIONS.
- 15. WATER HEATER SHALL BE RINNAI V65iN INDOR TANKLESS WATER HEATER (0.80 UEF; 10,300 BTU/H MINIMUN; 6.5 MAX GPM; CONNECTED TO NATURAL GAS) OR APPROVED EQUAL. FOLLOW MANUFACTURER'S RECOMMENDATIONS FOR PROPER INSTALLATION OF EQUIPMENT AND NEEDED PARTS (PIPING, VALVES, DRAINS, ETC.).
- 16. BACKFLOW PREVENTION DEVICE SHALL BE ZURN MODEL 975XL2TCU WITH TEST COCKS FACING UPWARD TO ALLOW INSTALLATION CLOSE TO WALL AND BATTERY OPERATED MONITOR SWITCH OR APPROVED EQUAL.
- 17. FLOOR DRAIN SHALL BE ZURN MODEL Z460B OR APPROVED EQUAL.
- 18. ALL BUILDING WATER PIPING SHALL BE COPPER.
- 19. CONTRACTOR SHALL FOLLOW MANUFACTURERS RECOMMENDATIONS FOR STORE AND INSTALLATIONS OF EQUIPMENTS.



United States Department of Agriculture Forest Service

(R02)
ROCKY MOUNTAIN REGION

PROJECT NAME

NORTH DELTA STORAGE BUILDING

GRAND MESA, UNCOMPAHGRE AND GUNNISON NATIONAL FORESTS

SUPERVISOR'S OFFICE NORTH DELTA SITE

DRAWING TITLE

# MECHANICAL AND PLUMBING NOTES

DWG SHEET NO.
$\neg$ MEP-03
SHEET <b>20</b> OF <b>23</b>



(R02)
ROCKY MOUNTAIN REGION

NORTH DELTA
STORAGE BUILDING

GRAND MESA, UNCOMPAHGRE AND GUNNISON NATIONAL FORESTS

SUPERVISOR'S OFFICE NORTH DELTA SITE

**ELECTRICAL PLAN** 

DATE XXXX-XX-XX	
ARCHIVE NO.	
XXX	
DESIGNER	DWG SHEET NO.
X.XXX	
DRAWN	<b>│</b> MEP-4
X.XXX	
CHECKED	
X.XXX	
PROJECT NO.	SHEET <b>21</b> OF <b>23</b>

# 2019-6-24 09:17 DMATOS C:\USERS\DMATOS\GMUG\N DELTA\NEW BUILDING\DWG\21\_TO

### NOTES

- 1. ALL ELECTRICAL WORK SHALL CONFORM TO THE NEC.
- 2. THE LAYOUT OF FIXTURES, OUTLETS & EQUIPMENT IS GENERALLY DIAGRAMMATIC UNLESS SPECIFICALLY DIMENSIONED. THE LAYOUT SHALL BE COORDINATED & CHECKED WITH THE BUILDING STRUCTURAL & FINISHED DETAILS, MECHANICAL & PLUMBING SYSTEMS FOR INTERFERENCES. ANY DISCREPANCY FOUND SHALL BE BROUGHT TO THE ATTENTION OF THE CO FOR RESOLUTION, PRIOR TO INSTALLATION.
- 3. ALL WORK INVOLVING CONNECTIONS TO SERVING UTILITY COMPANIES SHALL MEET THE REQUIREMENTS OF THAT UTILITY IN ADDITION TO THOSE REQUIREMENTS SPECIFIED & INDICATED IN THESE PLANS & SPECS.
- 4. CONTRACTOR SHALL PROVIDE ALL EQUIPMENTS, MATERIALS AND WORKMANSHIP NECESSARY TO COMPLETE THE WORK.
- 5. FIRE WALL PENETRATION & OPENINGS IN FIRE RATED WALLS SHALL BE SEALED BY AN APPROVED METHOD LISTED IN THE UL FIRE RESISTIVE DIRECTORY.

  PENETRATIONS THROUGH FIRE RATED WALLS SHALL BE SEALED WITH SCOTCH CP25 FIRE CAULK, 303 PUTTY OR APPROVED EQUAL.
- 6. ALL WIRING IN THE BAY 1 & 2 SHALL BE IN ELECTRICAL METALLIC TUBING (EMT) ON THE SURFACE WITH STEEL BOXES, 4" SQUARE BY 2 & DEEP & 1" RAISED STEEL COVERS FOR THE DEVICES AND BLANK COVERS FOR JUNCTION BOXES.

  MINIMUM SIZE EMT SHALL BE 1."
- 7. RECEPTACLES & SWITCHES IN BAY 1 & 2 SHALL BE LOCATED AT 42" ABOVE FINISHED FLOOR.
- 8. ALL RACEWAYS & CABLES SHALL CONTAIN AN EQUIPMENT GROUNDING CONDUCTOR. IF NO CONDUCTOR SIZE IS INDICATED ON THE DRAWINGS, THE CONDUCTOR SHALL BE SIZED IN ACCORDANCE W/ THE NEC 250-122.
- 9. ALL METAL BOXES SHALL BE GROUNDED BY BONDING THE CIRCUIT EQUIPMENT GROUNDING CONDUCTOR TO THE BOX WITH THE BOX GROUNDING SCREW. RECEPTACLES SHALL BE GROUNDED BY USE OF A PIGTAIL FROM THE CIRCUIT GROUNDING CONDUCTOR TO THE RECEPTACLE GROUNDING SCREW. REMOVAL OF THE RECEPTACLE SHALL NOT INTERRUPT THE CIRCUIT GROUNDING SYSTEM.
- 10. OFFICE & CONFERENCE ROOM: WIRING SHALL BE IN EMT OR WHEN CONCEALED WITHIN THE BUILDING MAY BE METAL—CLAD CABLE, TYPE MC. WHEN TYPE MC CABLE IS USED, APPROVED PLASTIC BOXES MAY BE UTILIZED.
- 11. OFFICE & CONFERENCE ROOM: SWITCHES & GFCI RECEPTACLES SHALL BE LOCATED 42" ABOVE FINISHED FLOOR. RECEPTACLES & TELEPHONE/DATA OUTLETS & SIMILAR DEVICES SHALL BE LOCATED 15" ABOVE FINISHED FLOOR TO CENTER OF THE BOX, UNLESS OTHERWISE NOTED. INTERIOR COVER PLATES FOR FLUSH MOUNTED SWITCHES, RECEPTACLES, TELEPHONE/DATA OUTLETS SHALL BE SMOOTH SURFACE THERMOPLASTIC.
- 12. CONTRACTOR SHALL INSTALL A DEDICATED CIRCUIT (240V) INSIDE BAY 2, NEXT TO EXTERIOR DOOR, FOR AN AIR COMPRESSOR. FINAL LOCATION TO BE APPROVE BY CONTRACTING OFFICER.
- 13. CONTRACTOR SHALL INSTALL A 40 AMP DEDICATED 240V CIRCUIT INSIDE BAY 2, NEXT TO EXTERIOR DOOR, FOR AN ARC WELDER, FINAL LOCATION TO BE APPROVED BY CONTRACTING OFFICER.

### NOTES (LIGHTING PLAN)

- 1. MOUNT LIGHT SWITCHES 42" ABOVE FINISHED FLOOR.
- 2. CONNECT EXHAUST FAN TO RESTROOM LIGHT SWITCH.

### NOTES (GENERAL)

1. SEE SHEET MEP-5 FOR LIGHT FIXTURE SCHEDULE, PANEL SCHEDULE, ONE-LINE SCHEMATIC AND FURTHER GENERAL NOTES.

### NOTES (POWER DISTRIBUTION PLAN)

- 1. ALL OUTLETS IN BAY 1 & 2 SHALL BE GFCI MOUNTED 42" ABOVE FINISHED FLOOR UNLESS OTHERWISE NOTED.
- 2. PROVIDE GFCI RECEPTACLES AT 42" ABOVE FLOOR ADJACENT TO LAVATORY IN EACH RESTROOM.
- 3. EXTERIOR GFCI RECEPTACLES SHALL BE LOCATED 36" ABOVE GRADE INSTALLED IN A RED DOT 1—GANG GFCI WEATHER PROOF NON— METALLIC BOX AND COVER (OR APPROVED EQUAL).
- 4. UNIT HEATERS IN ENGINE BAYS PROVIDE FUSED SWITCH MOUNTED ADJACENT TO UNIT HEATER, BUSS #SSY FUSETRON COVER ON 4" SQUARE BOX. FUSE AND CONNECTION TO UNIT HEATERS BY DIV. 26
- 5. CONDENSING UNIT DISCONNECT 30 AMPS, 2 POLE FUSIBLE NEMA 3R WITH 30 AMPS "FRN" FUSES. SURFACE MOUNT ADJACENT TO CONDENSING UNIT 36" ABOVE GRADE. SURFACE MOUNT 3/4" RIGID STEEL CONDUIT TO UNIT WITH FINAL 12" 18" IN LIQUIDITE FLEX W/ 2 # 10 CONDUCTORS AND 1 # 10 GROUND FUSES AND LOAD SIDE WIRING BY DIVISION 26.
- 6. ROLLING DOOR MOTOR OPERATORS INSTALL A 4" JUNCTION BOX. FINAL CONNECTION TO UNIT FLEX CONDUIT WITH 2 # 12 CONDUCTORS AND 1 # 12 GROUND. MOUNT DOOR OPERATORS AT 42" ABOVE FLOOR.
- 7. RESTROOM EXHAUST FANS SHALL BE NUTONE ULTRA—QUIET TEST MODEL QT100L.

### NOTES (TELECOMMUNICATION):

- 1. CONTRACTOR SHALL INSTALL NEW TELECOMMUNICATIONS LINE FROM EXISTING SERVICE TO NEW BUILDING.
- 2. CONTRACTOR SHALL PROVIDE A DEMARC BOARD 4' X 4'.
- 3. CONTRACTOR SHALL INSTALL CABLING AND OUTLETS FOR TELECOMMUNICATION WITH VOICE AND DATA JACKS FROM DEMARC BOARD TO OUTLETS.
- 4. DATA LINES SHALL BE CAT 6.
- 5. FINAL LOCATION OF VOICE AND DATA JACKS SHALL BE APPROVED BY CONTRACTING OFFICER.
- 6. MAIN TELEPHONE/DATA PANEL SHALL BE SET UP IN THE OFFICE AREA. PROVIDE DEMARC BOARD AND DEDICATED ELECTRICAL.
- 7. TELEPHONE/DATA OUTLETS SHALL HAVE A  $\frac{3}{4}$ " PVC CONDUIT FROM TOP OF MOUNTING PLATE TO DESIGNATED COMMUNICATION AREA IN OFFICE AREA...
- 8. TELEPHONE OUTLETS IN GARAGE SHALL BE 54" ABOVE FLOOR.



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# NORTH DELTA STORAGE BUILDING


### GRAND MESA, UNCOMPAHGRE AND GUNNISON NATIONAL FORESTS

SUPERVISOR'S OFFICE NORTH DELTA SITE

DRAWING TITLE

# ELECTRICAL PLAN NOTES

DWG SHEET NO.
<b>MEP-05</b>
22 22
SHEET <b>22</b> OF <b>23</b>

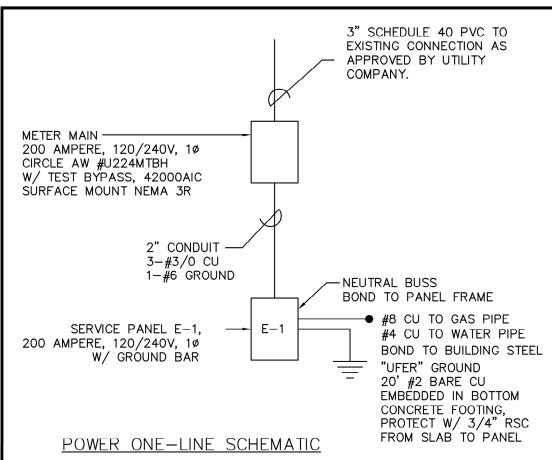

### LIGHT FIXTURE SCHEDULE NO. MANUFACTURER/ VOLTS MOUNT **REMARKS** LAMP TYPE CATALOG NO. LITHONIA 120 PENDANT CHAIN HUNG @ 15 FT. ADDITIONAL PARTS LED 40K ZL1N L48 NEEDED. 3,000LM. 25W. LITHONIA 120 SURFACE LED 40K 3,000LM. 25W. 2 3 ZL1N L48 WALL 120 LED DRIVER VISIONAIRE WALL MOUNTED AREA LIGHT CAST ALUMINUM 48W LED VSC-T3-48-700-HOUSING, IP65 RATED, DLC LISTED INTEGRAL 4K-UNV-WM-BK-40K, PHOTOCELL, -50°C OPERATING RATING 10843LM PC277 120 CEILING **PHILLIPS** 14WT5 MODEL SV-2-S-2-24-120-1/2EB DAY-BRITE (22")ATTIC LIGHTING, SWITCH ADJUST TO SVT5 ACCESS DOOR

WALL

NOTE: CONTRACTOR SHALL SUBMIT EQUAL PRODUCTS FOR APPROVAL BEFORE ORDERING MATERIAL.

DAY-BRITE

CXXL3RW

120

### LEGEND

EXIT SIGN.

<b>=</b>	DUPLEX RECEPTACLE 15A, 125V, BACK WIRED, IVORY, LEVITON #BR15-I
<b>⇔</b> GFCI	GFCI DUPLEX RECEPTACLE 15A, 125V, BACK WIRED, IVORY, LEVITON #6500-I
WP	WEATHER PROOF ENCLOSURE RED DOT 1—GANG GFCI WEATHER PROOF NON— METALLIC BOX AND COVER (OR APPROVED EQUAL)
<b>←</b> T	TELEPHONE/DATA OUTLET, CADDY #MP1S, UNLESS OTHERWISE NOTED
<b>(J)</b>	JUNCTION BOX, 4" SQUARE X 2 1/8" DEEP
M	ROLLING DOOR OPERATOR
S	SPST 15A, 125V, SWITCH, BACKED WIRED, IVORY, LEVITON #CSB1-15I
s <sub>os</sub>	OCCUPANCY SENSOR 15A, 125V, SWITCH, BACKED WIRED, IVORY, LEVITON #ODS06-IDW
S <sub>3</sub>	3-WAY 15A, 125V, SWITCH, BACKED WIRED, IVORY, LEVITON #CSB3-15I
PC	PHOTO CONTROL, FIXTURE MOUNTED SUPPLIED BY FIXTURE MANUFACTURER
<del>-</del>	CEILING MOUNTED FIXTURE
Ю-	WALL MOUNTED FIXTURE
Ψ <sub>E</sub> -ψ <sub>E</sub>	EMERGENCY EXIT LIGHTS
6	FIXTURE NUMBER, SEE FIXTURE SCHEDULE
(8)	BATHROOM EXHAUST FAN
NL/EM	NIGHT/EMERGENCY LIGHT - DO NOT SWITCH
S	SMOKE DETECTOR WITH STROBE LIGHT MODEL PC4WL



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DRAWING TITLE

ELECTRICAL DETAILS

DATE	
XXXX-XX-XX	
ARCHIVE NO.	
XXX	
DESIGNER	DWG SHEET NO.
X.XXX	
DRAWN	<b>■ MEP-06</b>
X.XXX	
CHECKED	
X.XXX	
PROJECT NO.	SHEET <b>23</b> OF <b>23</b>

PANEL E-1 SCHEDULE 200 AMPERE, 120/240V, 10

LOAD NAME	C.B.	CIR. NO.		CIR. NO.	C.B.	LOAD NAME
LIGHTS- BAY 1	20 1	1	+	2	20 1	RECEPTACLES BAY 1
LIGHTS- BAY 1	20 1	3		4	20 1	RECEPTACLES BAY 1
EXTERIOR LIGHTS	20 1	5		6	20_1	RECEPTACLES BAY 1
BAY 1 & 2 DOOR OPENERS	20 1	7		8	20_1	UNIT HEATERS
RECEPTACLES OFFICE	20 1	9		10	20 1	LIGHTS OFFICE AND BATHROOMS
RECEPTACLES OFFICE	20 1	11		12	20_1	FURNACE
AC CONDENSER	30	13		14	20 1	WATER HEATER
AC CONDENSER	2	15	<b></b>	16		SPARE
RECEPTACLES BAY 2	20 1	17		18	20 1	LIGHTS- BAY 2
RECEPTACLES BAY 2	20 1	19		20		SPARE
SPARE		21		22	40	WELDER
SPARE		23		24	2	WELDER
SPARE		25		26	40	AIR COMPRESSOR
SPARE		27		28	2	AIR COMPRESSOR
SPARE		29		30		SPARE