ADDENDUM #9

Chamberlin Architects, P.C. 437 Main Street Grand Junction, CO 81501

Western Slope Food Bank of the Rockies 698 Long Acre Drive

Bid Package #4 – Above Ground

Architect's Project No. 2108

September 15, 2021

The original Project Manual dated 8/25/21 and Drawings dated on 8/25/21, for the project noted above are amended as noted in this Addendum. This Addendum may include revised Drawings that are to be inserted in the correct sequence in the Construction Issue. All bidders are required to include the items listed in the Addendum as part of their bid. This Addendum consists of **one (1)** page plus attachments.

Drawing changes are clouded.

Text deleted from the project manual by this addendum is indicated by Strikethrough (example). New text included in the Project manual is indicated in double underline typeface (example).

DESCRIPTION ITEM NO.

<u>DRAWINGS</u>


ADD9-1

Replace all Foodservice drawings, sheets FS1.0, FS1.1, FS1.1A, FS1.2, FS1.3, FS1.4, FS2.0, FS2.1, FS2.2, and FS2.3 with the attached reissued sheets. All changes to the sheets are in red text and are limited to clarifications about what scope is within this contract and what will be under separate contract.

END OF ADDENDUM 9

Chamberlin Architects, P.C. ARCHITECT:

Eric Mendell, AIA BY:

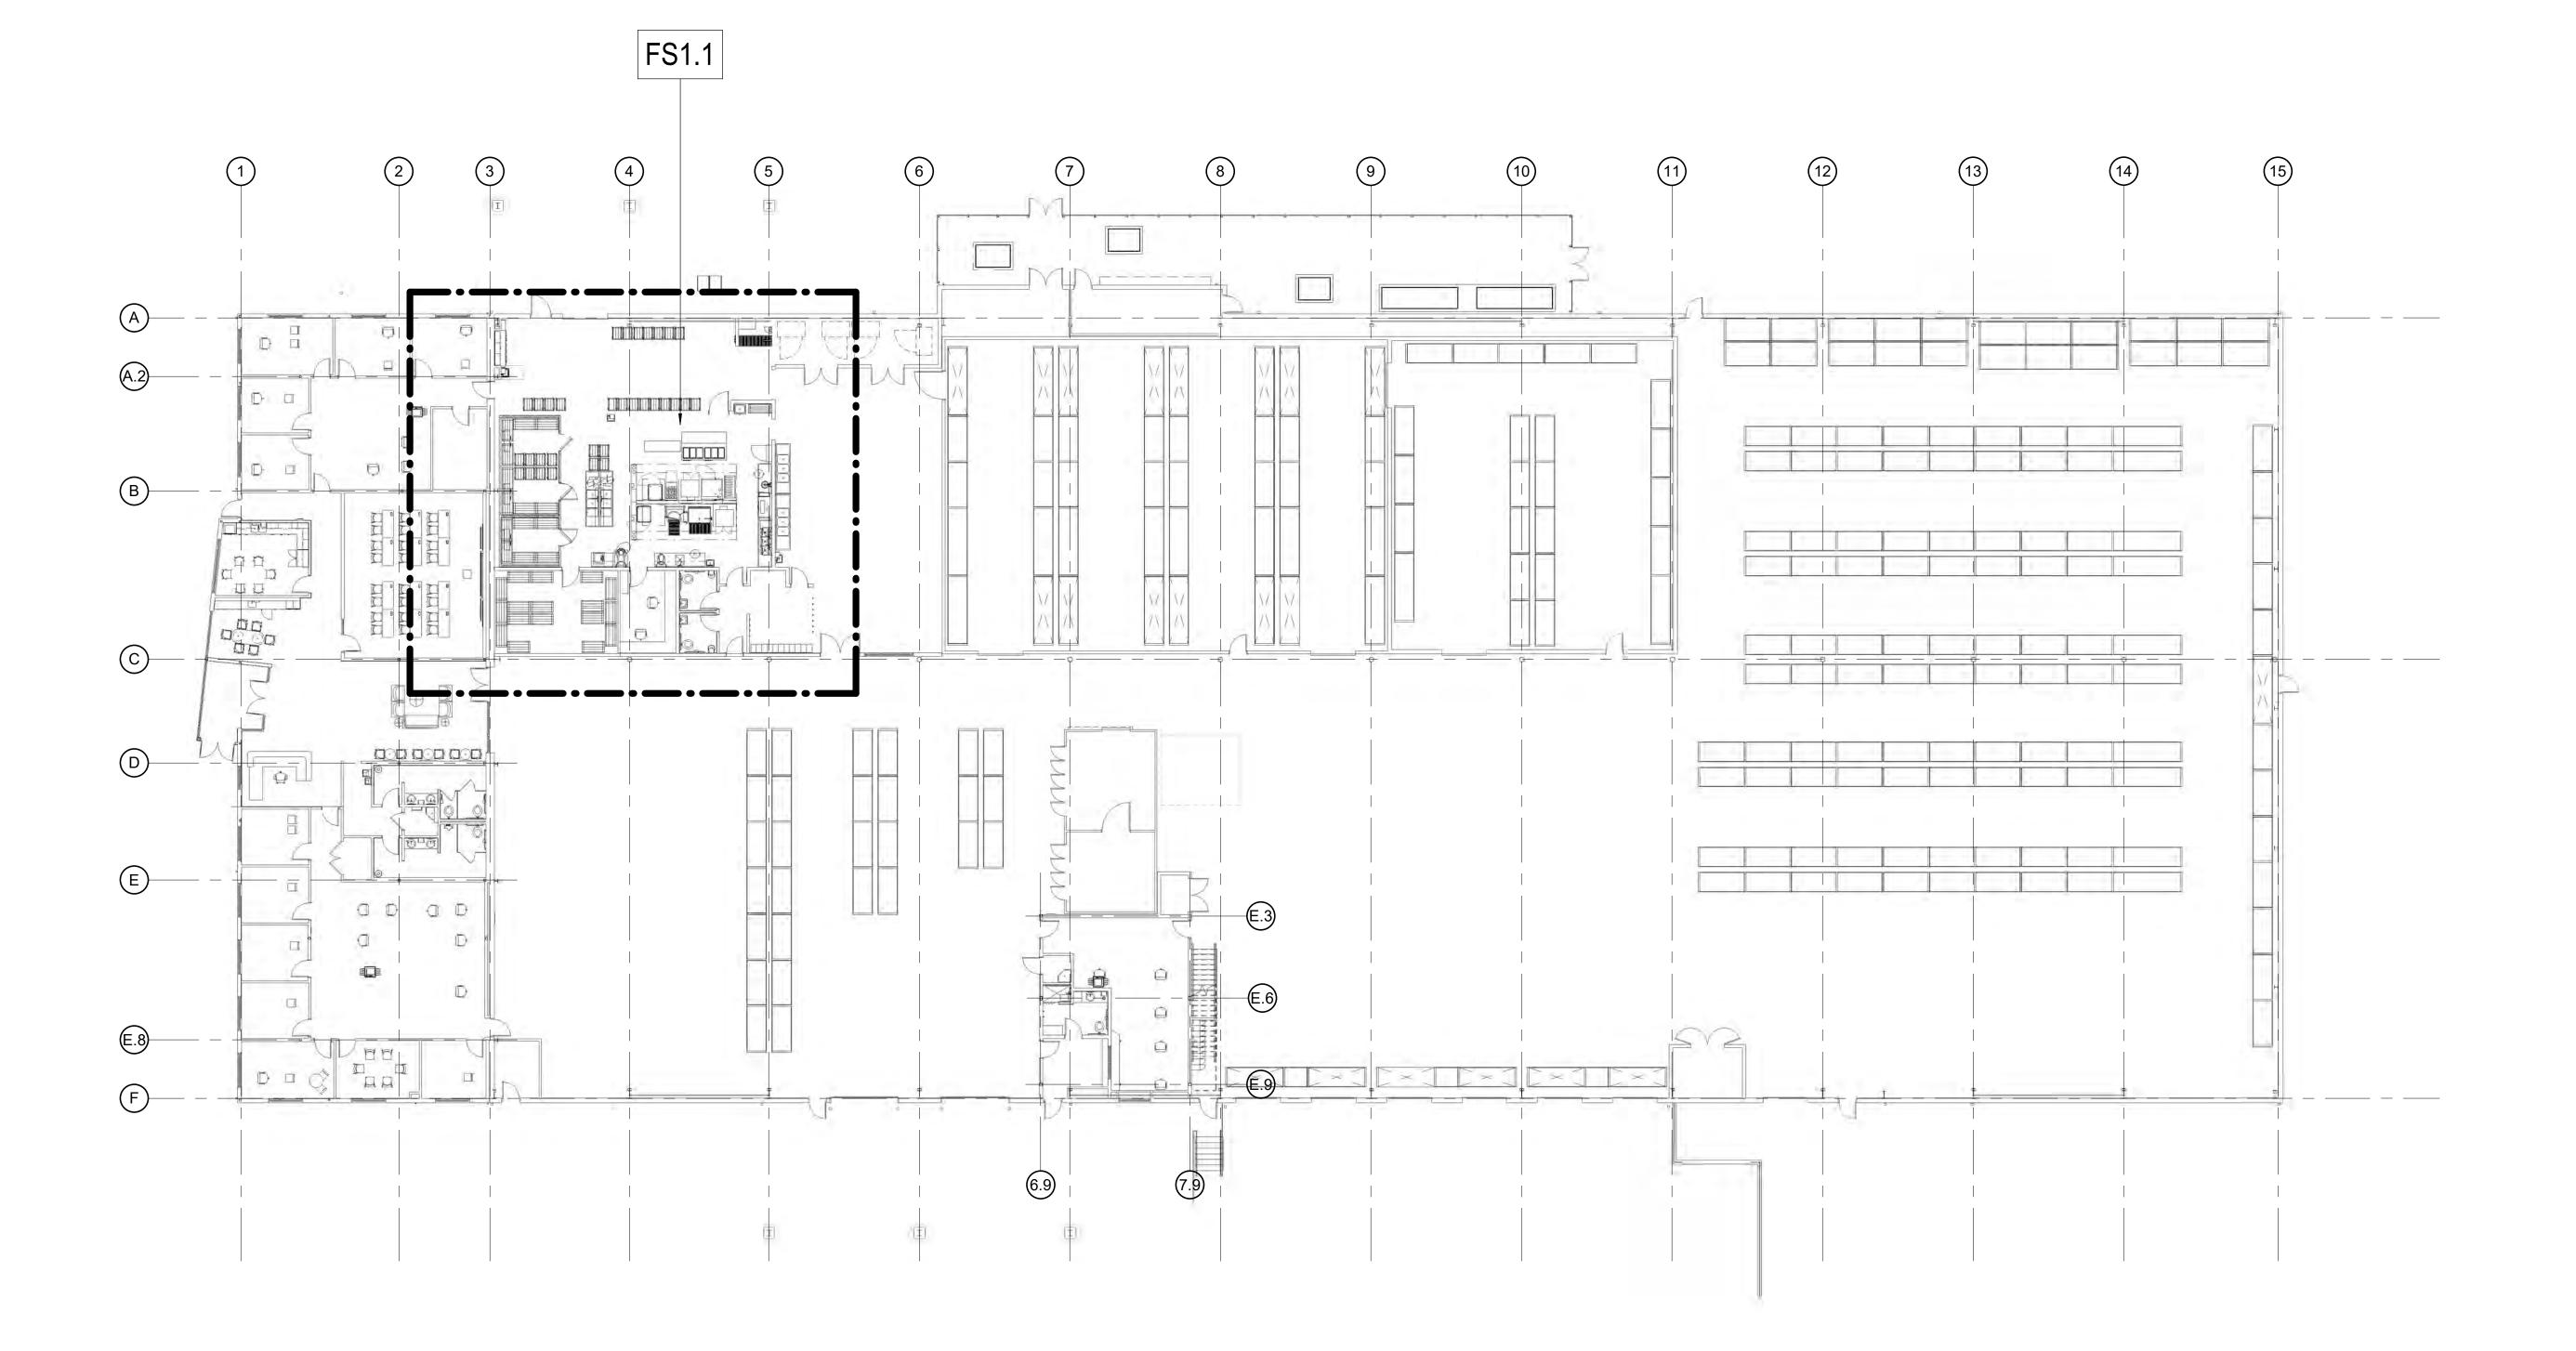

OVERALL FOODSERVICE PLAN SCALE:1/16" = 1'-0"

chamberlin 437 Main Street

437 Main Street Grand Junction, CO 81501 970.242.6804 chamberlinarchitects.com

FOOD BANK OF THE ROCKIES

698 LONG ACRE DRIVE GRAND JUNCTION, COLORADO


OVERALL FOODSERVICE EQUIPMENT PLAN

NO: ISSUED FOR: DA

100% CONSTRUCTION DOCUMENTS

DATE: 8/25/2021


FS1

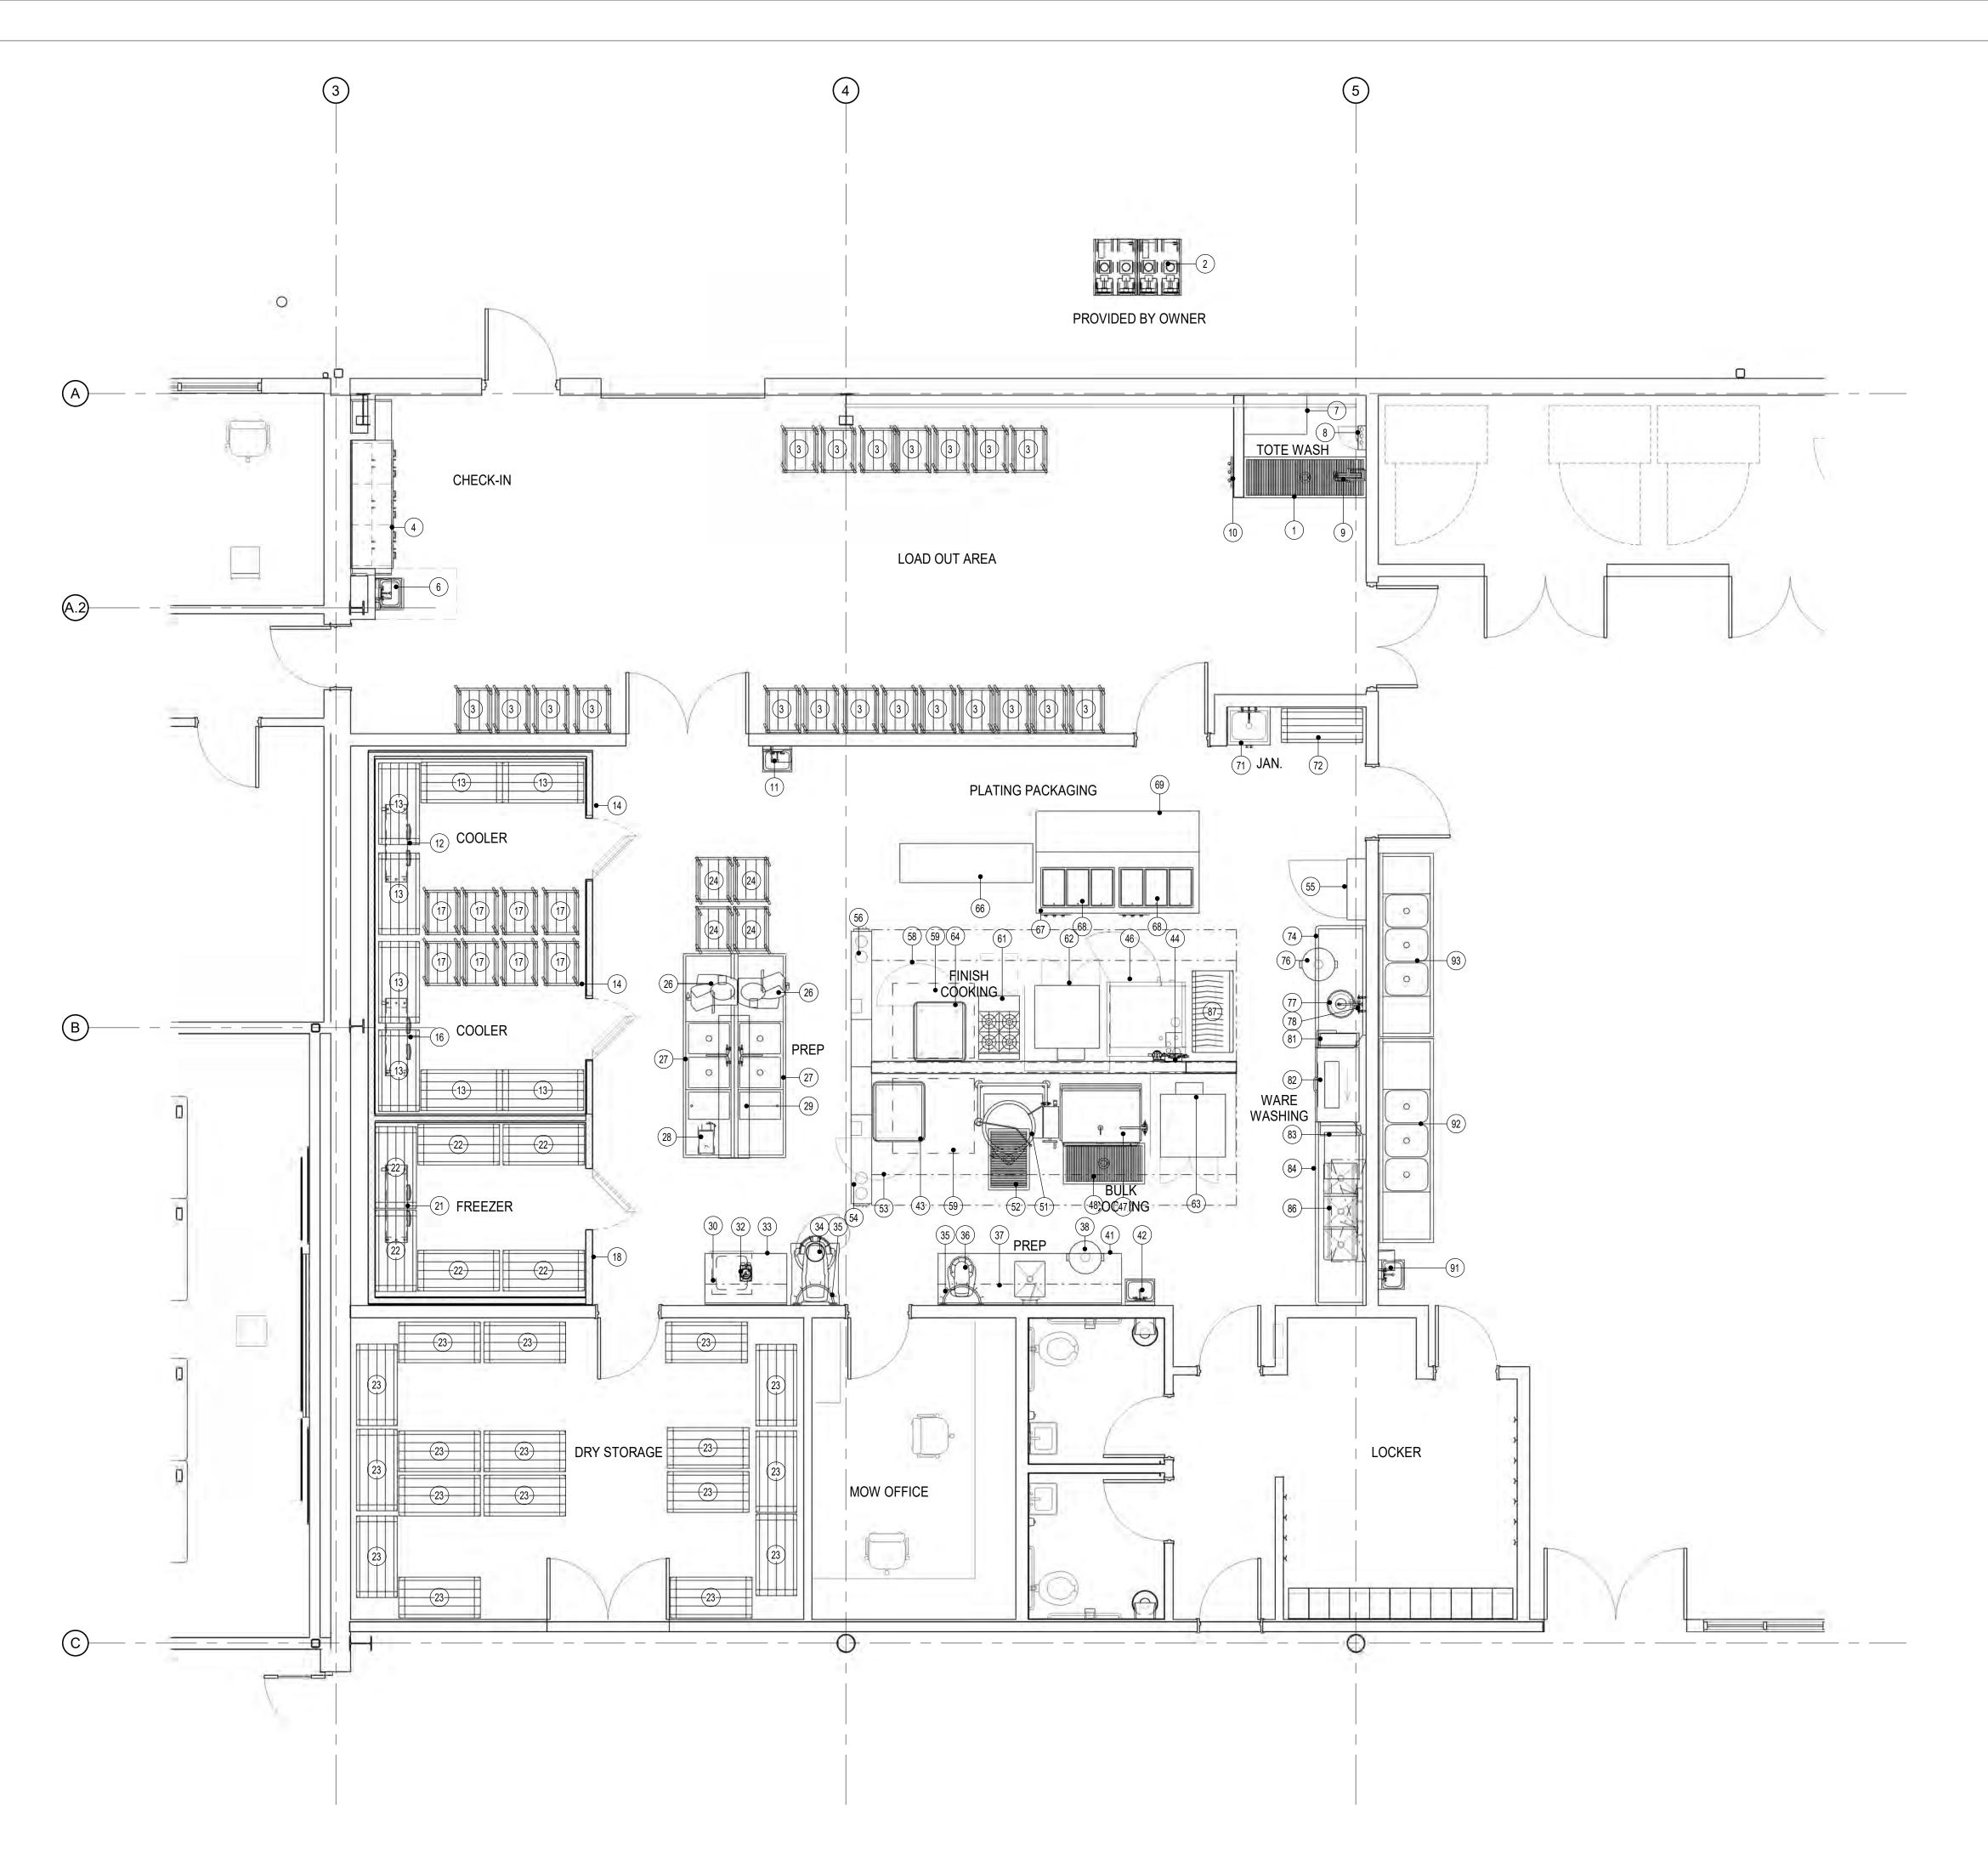

KITCHEN - FOODSERVICE EQUIPMENT PLAN SCALE: 1/4" = 1'-0"

EQUIPMENT NOTED BELOW AS "GC" SHALL BE PROVIDED (FURNISHED AND INSTALLED)
IN THIS CONTRACT. ALL OTHER EQUIPMENT LISTED ON THIS SHEET WILL BE UNDER
SEPARATE CONTRACT AND IS LISTED FOR REFERENCE AND COORDINATION
PURPOSES ONLY. MECHANICAL, PLUMBING, AND ELECTRICAL ROUGH-IN AND WALL
BLOCKING FOR ALL EQUIPMENT SHALL BE PROVIDED UNDER THIS CONTRACT. REFER
TO SPECIFICATION SECTION 114000 FOODSERVICE EQUIPMENT FOR ADDITIONAL
INFORMATION AND REQUIREMENTS RELEVANT TO THE WORK WITHIN THE SCOPE OF
THIS CONTRACT.

TEM NO	QTY	i i	EQUPMENT REMARKS
2	1 1	FLOOR TROUGH WALK IN COMPRESSOR RACK	BY OWNER
3	20	PAN RACK W/ MOW TOTES	BT OWNER
4	1	CHECK IN DESK	MILLWORK / BY GENERAL CONTRACTOR
5	-	SPARE NUMBER	
6 7	1 1	HAND SINK WORK TABLE, MOBILE	SOAP & TOWEL BY OWNER
8	1	SANITIZER STATION W/ SPRAY	
9	1	HOSE REEL WITH SPRAY	
10	1	MOP RACK	
11	1	HAND SINK	SOAP & TOWEL BY OWNER
12 13	1 8	EVAPORATOR COIL COOLER STORAGE SHELVING	BY OWNER
14	1	WALK-IN COOLER	BY OWNER
15	-	SPARE NUMBER	
16	1	EVAPORATOR COIL	BY OWNER
17 18	12 1	PAN RACK W/ MOW TOTES WALK-IN FREEZER	BY OWNER
19	<u>'</u>	SPARE NUMBER	BI OWNER
20	-	SPARE NUMBER	
21	1	EVAPORATOR COIL	BY OWNER
22	6	FREEZER STORAGE SHELVING	
23 24	17 12	DRY STORAGE SHELVING PAN RACK W/ MOW TOTES	
25	-	SPARE NUMBER	
26	2	SLICER	BYOWNER
27	1	PREP TABLE W/ SINK	
28	1	FOOD CHOPPER	BY OWNER CLISTOM FARRICATION
29 30	<u>1</u> 1	OVERSHELF WALL SHELF	CUSTOM FABRICATION
31	-	SPARE NUMBER	
32	1	FOOD PROCESSOR	
33	1	WORK TABLE W/ DRAWER	
34 35	1 	60QT FLOOR MIXER MIXER UTENSIL RACK	CUSTOM FABRICATION
36	1	20QT MIXER	SST SWITZERIOTHOU
37	1	WALL SHELF	
38	1	TRASH RECEPTACLE	BY OWNER
39	-	SPARE NUMBER	
40	<u>-</u> 1	SPARE NUMBER WORK TABLE W/ SINK	
42	1	HAND SINK	SOAP & TOWEL BY OWNER
43	1	HEATED CABINET	
44	1	WATER FILTER	FOR ITEM# 46
45 46		SPARE NUMBER DOUBLE FULL SIZE COMBI OVEN,GAS	
47	<u>'</u> 1	TILT SKILLET	
48	1	FLOOR TROUGH	
49	-	SPARE NUMBER	
50 51	 1	SPARE NUMBER KETTLE	
52	1	FLOOR TROUGH	
53	1	EXHAUST HOOD	
54	1	FIRE SUPPRESSION SYSTEM	FOR ITEM #53
55 56	1 1	HOOD CONTROL PANEL FIRE SUPPRESSION SYSTEM	FOR ITEM #53, 58 FOR ITEM #58
58	1	EXHAUST HOOD	FOR ITEM #50
59	2	COMBIOVEN	FUTURE
60	-	SPARE NUMBER	
61	1	4 BURNER RANGE	DELOCATE & INICTALL CAMPED EVO CONTROL
62 63	<u>1</u> 1	DOUBLE CONVECTION OVEN DOUBLE CONVECTION OVEN	RELOCATE & INSTALL OWNER EXG OVEN RELOCATE & INSTALL OWNER EXG OVEN
64	1	HEATED CABINET	
65	<u> </u>	SPARE NUMBER	
66	1	PACKAGING MACHINE	
67	2	WORK TABLE	
68 69	1	HEAT WELL, 3 WELL WORK TABLE	
70	-	SPARE NUMBER	
71	1	MOP SINK STORAGE CABINET	
72	1	DRY STORAGE SHELVING	
73 74	 1	SPARE NUMBER SOILED DISHTABLE	
74 75	<u> </u>	SPARE NUMBER	
76	1	TRASH RECEPTACLE	BYOWNER
77	1	DISPOSER	
78 79	1	PRE-RINSE FAUCET, BACKSPLASH MOUNT	
79 80	-	SPARE NUMBER SPARE NUMBER	
81	1	VENT-LOAD END	
82	1	WAREWASHER W/ BOOSTER HEATER	
83	1	VENT-UNLOAD END	
84	1	DISHTABLE W/3 COMPARTMENT SINK	
85 86	<u>-</u> 1	SPARE NUMBER RACK SHELF	
87	1	POT AND PAN SHELVING	
88		SPARE NUMBER	
89	-	SPARE NUMBER	
90	-	SPARE NUMBER	COAD & TOWNER BY OWNER
91 92	<u>1</u> 1	HAND SINK 3 COMPARTMENT SINK	SOAP & TOWEL BY OWNER
92	1	3 COMPARTMENT SINK 3 COMPARTMENT SINK	
	•	SPARE NUMBER	

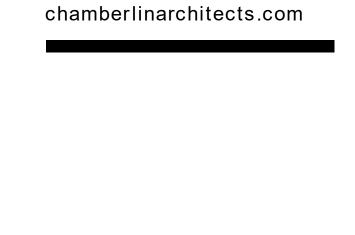

chamberlin

Grand Junction, CO 81501

437 Main Street

970.242.6804

FOOD BANK OF THE ROCKIES

698 LONG ACRE DRIVE GRAND JUNCTION, COLORADO

FOODSERVICE EQUIPMENT PLAN

NO:	ISSUED FOR:	DATE:
	ADDENDUM #9	9/15/202

100% CONSTRUCTION DOCUMENTS

8/25/2021

PROJECT NO:

ALL MECHANICAL, PLUMBING, AND ELECTRICAL ROUGH-IN FOR ALL EQUIPMENT SHOWN SHALL BE PROVIDED UNDER THIS CONTRACT.
REFER TO FS1.1 FOR WHICH EQUIPMENT IS UNDER THIS CONTRACT OR BY OTHERS.

								UTILITIES SCHEDULE																
ITEM NO QTY EQUIPMENT CATEGORY	EQUIPMENT REMARKS	AMPS	ΚW	VOLTS	PHASE	PLUG	ELECTRICAL AFF	ELECTRICAL REMARKS	COLD WATER SIZE (IN)	COLD WATER AFF	HOT WATER SIZE (IN)	HOT WATER AFF (IN)	DIRECT DRAIN SIZE (IN)	DIRECT DRAIN AFF (IN) Indirect Waste Size	Gas Size	Gas Input	PLUMBING REMARKS	HVAC EXHAUST DUCT SIZE (IN)	HVAC EXHAUST CFM	HVAC EXHAUST SPWG	HVAC MAKE-UP AIR DICT SIZE (IN)	HVAC MAKE-UP CFM	HVAC MAKE-UP SPWG	HVAC REMARKS
1 1 FLOOR TROUGH														2.00										
4 1 CHECK IN DESK	MILLWORK / BY GENERAL CONTRACTOR	10.0 A		120 1		X 48	8	DATA						2.00										
6 1 HAND SINK	SOAP & TOWEL BY OWNER								0.50 2	24 0.	.50		1.50	18										
7 1 WORK TABLE, MOBILE		6.0 A		120 1		X ST	TUB-UP		0.00		.00		0.00	0.00		0								
8 1 SANITIZER STATION W/ SPRAY		5.0 A		120 1	X	48	8		0.50 4															
9 1 HOSE REEL WITH SPRAY									0.50 7			72												
11 1 HAND SINK	SOAP & TOWEL BY OWNER	540		100	,	V 20	0		0.50 2	24 0.	.50	24	1.50	18										
26 2 SLICER 27 1 PREP TABLE W/ SINK	BY OWNER	5.4 A 10.0 A		120 1 120 1	,	X 38	8 9	CONVENIENCE OUTLET	0.50 0) 0	.50	0		1.50										
28 1 FOOD CHOPPER	BY OWNER	16.0 A	1.5	120 1	- 4	X 38	o 8	CONVENIENCE OUTLET	0.50 0	0.	.50	U		1.50										
32 1 FOOD PROCESSOR	BI OWNER	5.0 A	1.5	120 1	,	X 38	8																	
33 1 WORK TABLE W/ DRAWER		10.0 A		120 1		X 48	8	CONVENIENCE OUTLET	0.50 1	8 0.	.50	18		1.50										
34 1 60QT FLOOR MIXER		10.0 A	2.7	208 3	X	18		0011121102001221	0.00	0.	.00	1.0		1.00										
36 1 20QT MIXER		8.0 A	1/2	120 1		X 48	8																	
41 1 WORK TABLE W/ SINK		10.0 A		120 1		X 48	8		0.50 1	8 0.	.50	18		1.50										
42 1 HAND SINK	SOAP & TOWEL BY OWNER								0.50 2	24 0.	.50	24	1.50	18										
43 1 HEATED CABINET		8.8 A		120 1		X 18	8																	
44 1 WATER FILTER	FOR ITEM# 46								0.50 4															
46 1 DOUBLE FULL SIZE COMBI OVEN,GAS		7.8 A		120 1		X 24	4/48		0.75 F					1.00		106500 24								
47 1 TILT SKILLET		0.2 A		120 1		X 24	4		0.50 2	24 0.	.50	24			0.75	130000 24								
48 1 FLOOR TROUGH														2.00										
51 1 KETTLE		10.0 A		120 1		X 24	4		0.50 2	24 0.	.50	24			0.50	190000 24								
52 1 FLOOR TROUGH				1.55	.,									2.00				(2) (2)						
53 1 EXHAUST HOOD	FOR ITEM (IFO	20.0 A 20.0 A		120 1	X			FOR LIGHTS & FAN										(2)12X14	1800(EA)	0.51	(4)8x24	720(EA)	0.11	
54 1 FIRE SUPPRESSION SYSTEM	FOR ITEM #53			120 1	X		ROM ABOVE																	
55 1 HOOD CONTROL PANEL 56 1 FIRE SUPPRESSION SYSTEM	FOR ITEM #53, 58 FOR ITEM #58	20.0 A 20.0 A		120 1 120 1	X		ROM ABOVE ROM ABOVE																	
58 1 EXHAUST HOOD	I ON ITEIN #30	20.0 A		120 1	\\ \ \ \ \ \ \ \ \ \ \ \ \ \ \ \ \ \ \		ROM ABOVE	FOR LIGHTS & FAN										(2)12Y1A	1800(EA)	0.51	(4)8×24	720(EA)	0 11	
59 2 COMBIOVEN	FUTURE	7.8 A		120 1			4/48	, SILLISITIO GI AN	0.50 4	-8		0		1 00	0.75	106500 24		(4)14/14	1000(LA)	0.01	(7)0^24	, 20(LA)	0.11	
61 1 4 BURNER RANGE							.		0.50					1.50		132000 24								
62 1 DOUBLE CONVECTION OVEN	RELOCATE & INSTALL OWNER EXG OVEN	6.0 A		120 1		X 24	4/48								0.75	55000 24								
63 1 DOUBLE CONVECTION OVEN	RELOCATE & INSTALL OWNER EXG OVEN	6.0 A		120 1			4/48								0.75	55000 24								
64 1 HEATED CABINET		8.8 A		120 1		X 18	8																	
66 1 PACKAGING MACHINE		6.0 A		120 1			ROM ABOVE, DROP CORD		0.00		.00	0	0.00	0.00		0								
67 1 WORK TABLE		10.0 A		120 1			ROM ABOVE, DROP CORD		0.00		.00	0		0.00										
68 2 HEAT WELL, 3 WELL		17.9 A		208 1			ROM ABOVE, DROP CORD		0.25 S					0.50										
69 1 WORK TABLE		10.0 A		120 1		X FF	ROM ABOVE, DROP CORD		0.00	I	.00	0	0.00	0.00										
71 1 MOP SINK STORAGE CABINET		0.0.4		000		1.0	0		0.50 3		.50		2.00											
77 1 DISPOSER 78 1 PRE-RINSE FAUCET, BACKSPLASH MOUNT		3.3 A	2	208 3	X	18	8		0.50 F		75		2.00	22										
·		0.0.4							0.75 2	24 0.	.75	24						4"504"	200	0.25"				
81 1 VENT-LOAD END 82 1 WAREWASHER W/ BOOSTER HEATER		0.0 A 50.0 A	2.25	200		24	<u> </u>		0.75 7	72	.75	72		1.50	0.00			4"x24"	200	0.25"				
82 1 WAREWASHER W/ BOOSTER HEATER 83 1 VENT-UNLOAD END		0.0 A	2.25	208 3	X	24	+		0.75 /	2 0.	. / ບ	72		1.50	0.00			4"x24"	400	0.25"				
84 1 DISHTABLE W/3 COMPARTMENT SINK		0.0 A		0					0.50 1	8 0	.50	18		1.50				7 124	+00	0.20				
91 1 HAND SINK	SOAP & TOWEL BY OWNER								0.50 1				1.50											
92 1 3 COMPARTMENT SINK	SOAI G TOWELD I OWNER								0.50 2			18	1.50	1.50										
93 1 3 COMPARTMENT SINK									0.00 1			18		1.50			_							



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FOOD BANK OF THE ROCKIES

698 LONG ACRE DRIVE GRAND JUNCTION, COLORADO


UTILITIES SCHEDULE

NO:	ISSUED FOR:	DATE:
	ADDENDUM #9	9/15/2021

100% CONSTRUCTION DOCUMENTS

DATE: 8/25/2021 SHEET NO:


DJECT NO: EC1

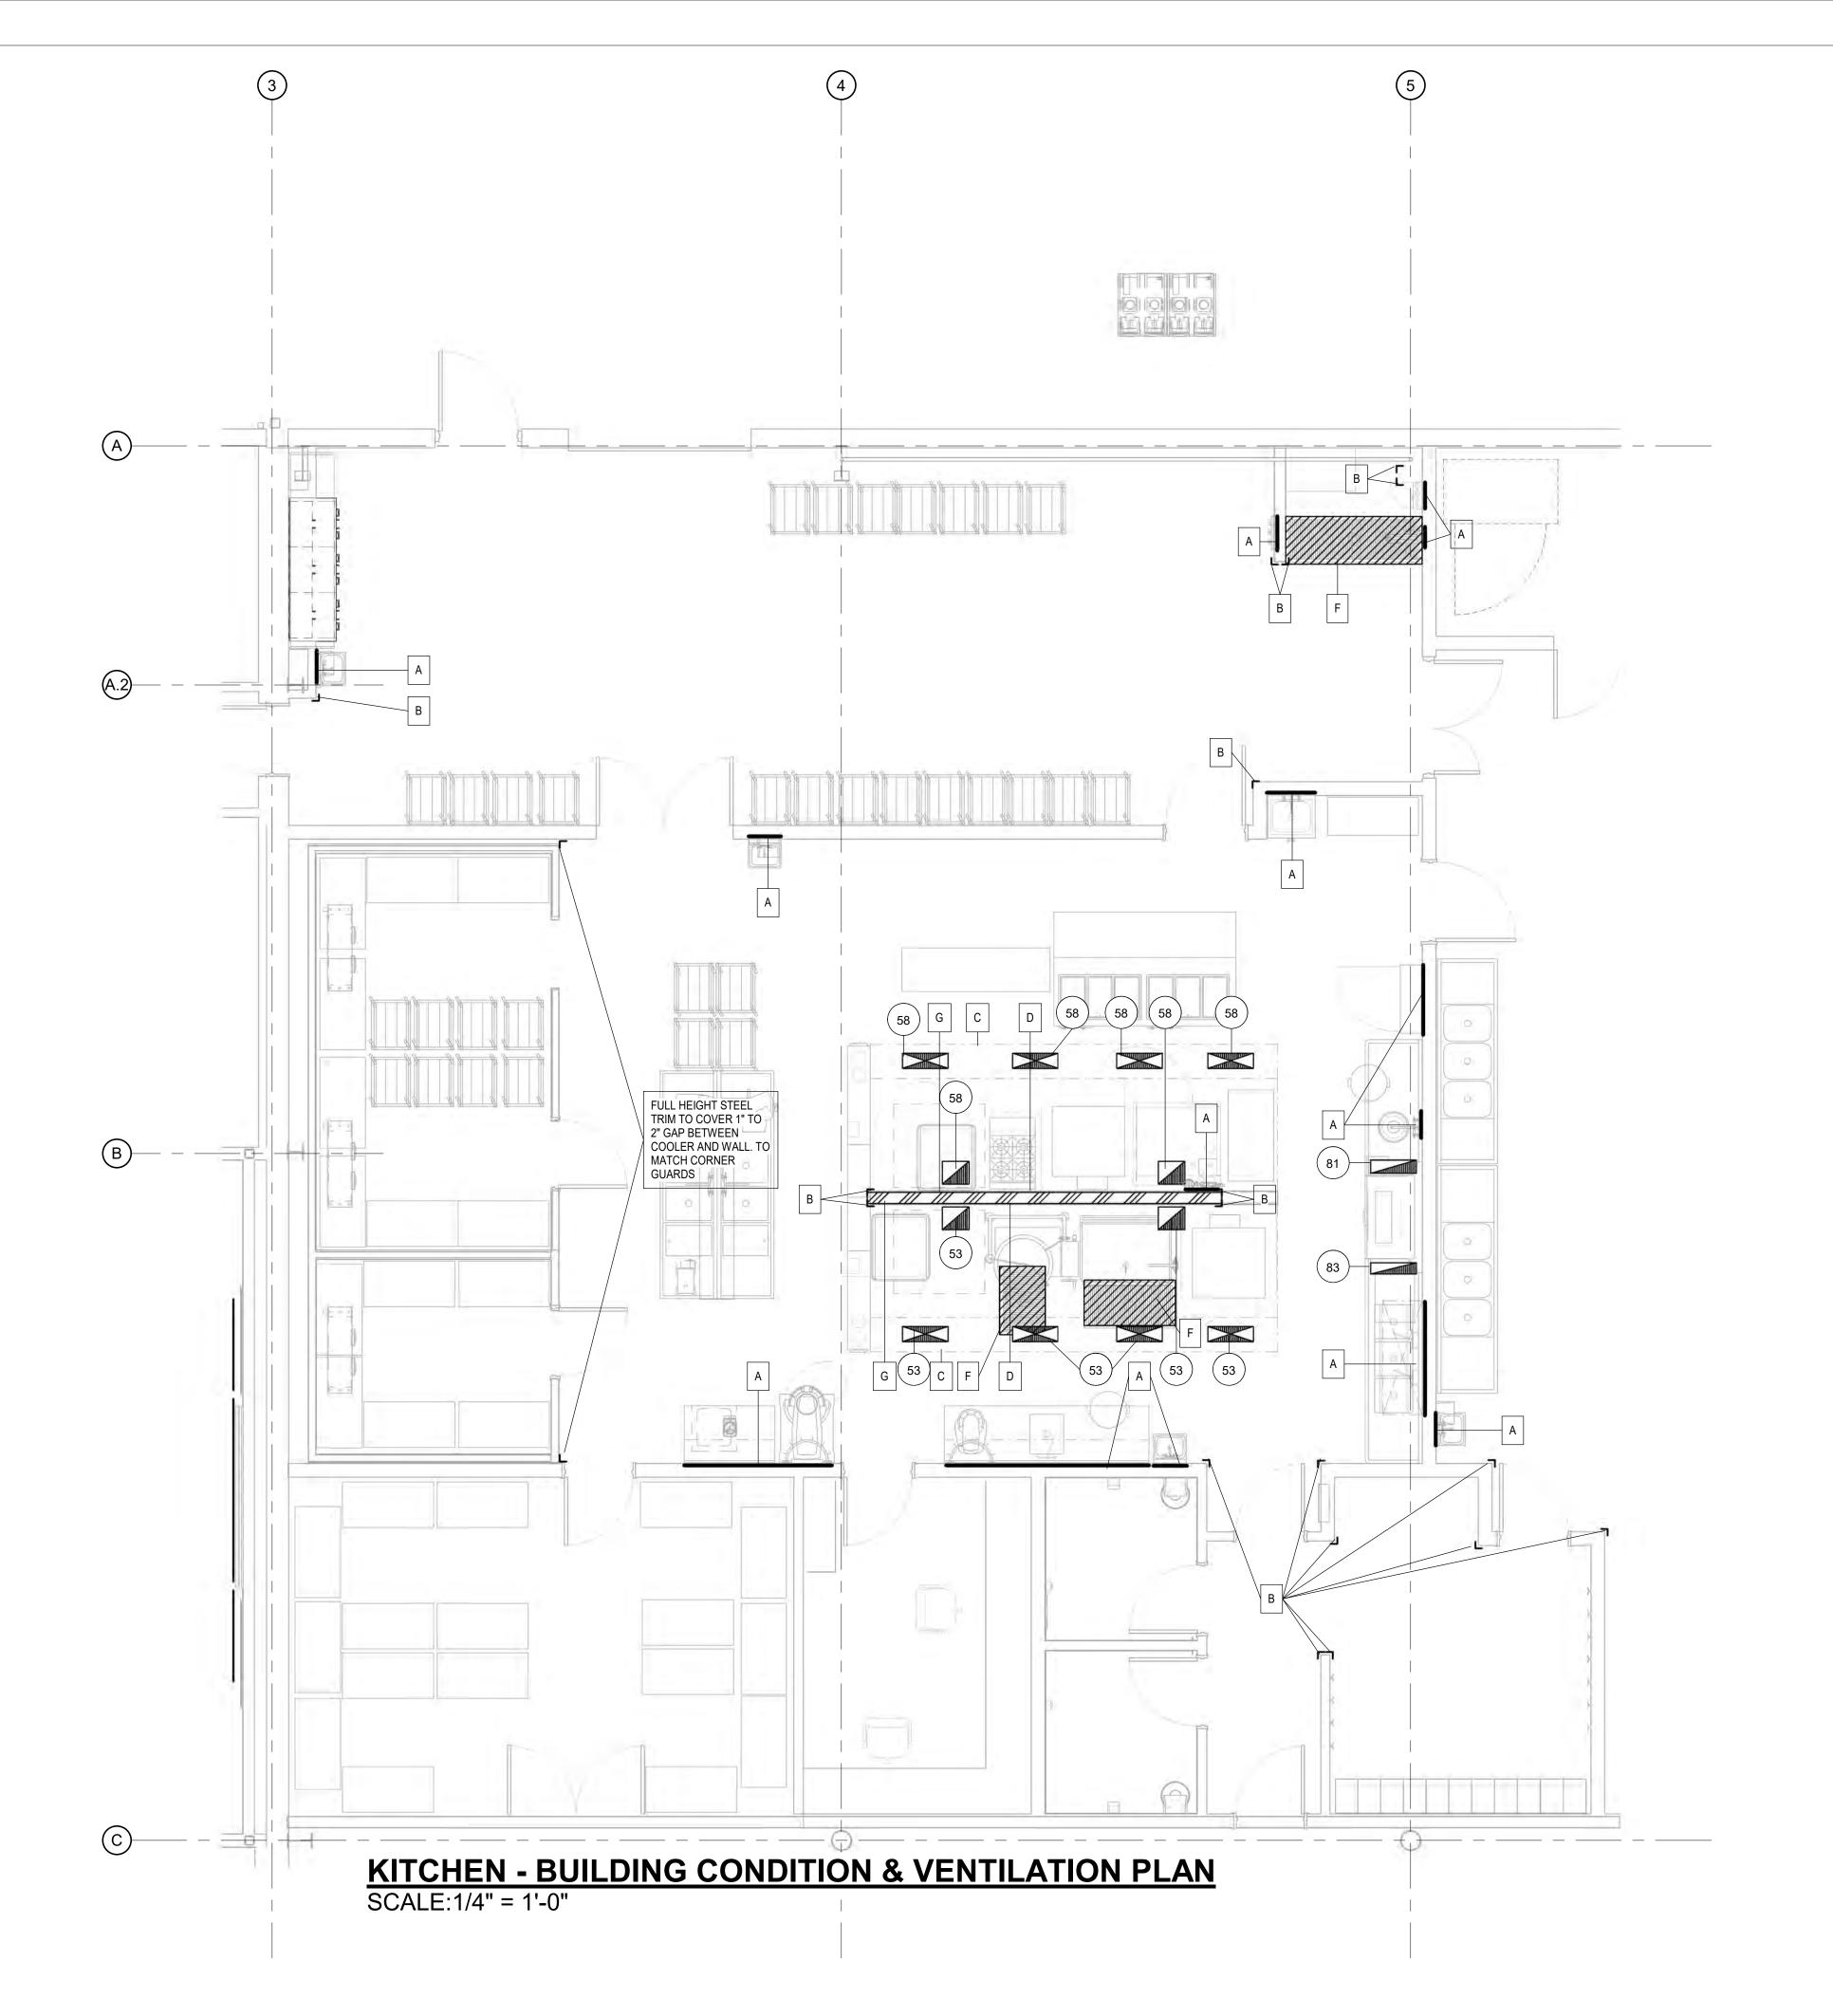



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ALL WORK SHOWN ON THIS SHEET SHALL BE PROVIDED IN THIS
CONTRACT, INCLUDING MECHANICAL, PLUMBING, AND ELECTRICAL
ROUGH-IN, WALL BLOCKING, AND CORNER GUARDS AND TRIM AS SHOWN.

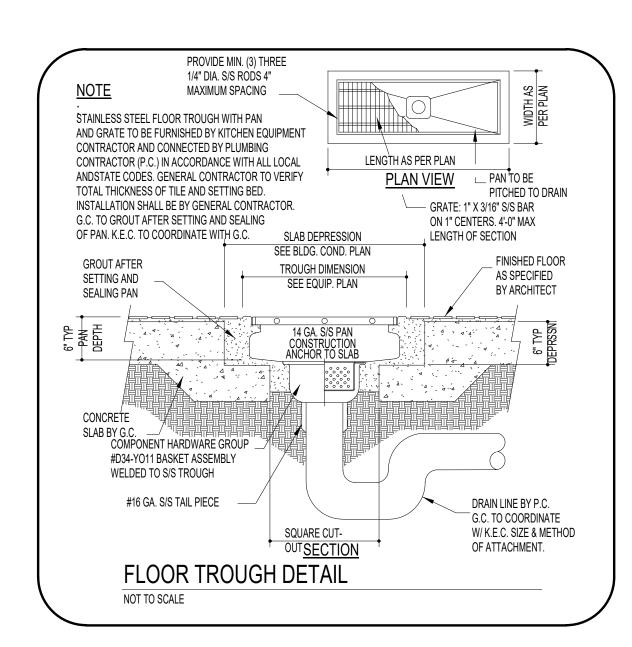

MECHANICAL LEGEND

EXHAUST DUCT CONNECTION

MAKE-UP AIR DUCT CONNECTION

AIR COOLING (HEAT REMOVAL)

FLOOR AREA SPEACIAL NOTES

NON-COMBUSTIBLE WALL (BY GENERAL CONTRACTOR)

LOW WALL PARTITION

LOW WALL PARTITION

BUILDING COND. & VENTILATION NOTES

- A WALL BACKING, BY G.C. VERIFY SIZE & LOCATION WITH F.E.C.
- B 3" X 3" X 60" HIGH 16 GA. S/S CORNER GUARDS, BY F.E.C., TYPICAL

 GENERAL CONTRACTOR TO PROVIDE STRUCTURAL SUPPORT ABOVE FOR CEILING
- HUNG EQUIPMENT SEE EQUIPMENT SHOP DRAWING FOR MOUNTING INFORMATION

 20 GA. S/S WALL FLASING FROM BASE COVE TO BOTTOM LINE OF HOOD
 BY F.E.C. (INCLUDE WITH THE HOOD @ WALL LOCATION)
- E WALK-IN AREA TO BE LEVELED TO 1/8" TOLERANCE UNDER WALK-IN FLOOR PLANELS PER MANUFACTURER'S REQUIREMENTS (COODINATE W/
- INSTALLER).

 BOX-OUT IN FLOOR SLAB FOR FLOOR TROUGH SIMILAR TO FLOOR TROUGH SECTION IN THIS SHEET
- G PROVIDE FOR NON-COMBUSTIBLE WALL CONSTRUCTION @ ALL COOK LINE WALLS
- H 8" BEER CONDUIT/CHASEWAY BY G.C. FOR BEER SYSTEM. CONDUIT SHALL HAVE 24"
 RADIUS AT ALL BENDS & TERMINATE 6" ABOVE FIN. FLOOR. K.E.C. TO SEAL TOPS OF
 CONDUIT AFTER BEVERAGE SYSTEM INSTALLATION IS COMPLETE. VERIFY WITH LOCAL
 CODES.

KITCHEN BUILDING CONDITIONS & VENTILATION NOTES

THE INFORMATION CONTAINED ON THIS DRAWNG HAS BEEN COORDINATED WITH THE ARCHITECT AND ENGINEERS. CONTRACTORS SHALL VERIFY LOCATION OF ROUGH-INS AND SERVICE REQUIREMENTS WITH FIELD DIMENSIONS AND CONDITIONS. COORDINATE INSTALLATION REQUIREMENTS OF FOOD/BEVERAGE SERVICE EQUIPMENT WITH FOODSERVICE EQUIPMENT CONTRACTOR (F.E.C.). EQUIPMENT DESIGNATED BY NFSC IS DEFINED AS "NOT IN FOODSERVICE CONTRACT".

- 1. ALL WORK INDICATED ON THIS PLAN AND IN THESE NOTES ARE TO BE BY OTHERS THAN THE FOODSERVICE EQUIPMENT CONTRACTOR (F.E.C.) UNLESS NOTED.
- 2. THE BUILDING CONDITIONS & VENTILATION PLAN IS INTENDED TO SHOW PRELIMINARY ROUGH-IN LOCATIONS AND HEIGHTS, CONNECTION SIZES, AND LOAD REQUIREMENTS. FOR FINAL LOCATIONS SEE F.E.C. DIMENSIONED PLANS. DIMENSIONS, WHEN SHOWN, ARE FROM COLUMN CENTERS OF FINISHED FLOORS, AND FINISHED WALLS.
- 3. WALLS, FLOORS, AND CEILINGS IN KITCHEN, PREPARATION, SERVICE, AND WAREWASHING AREAS OR ANY OTHER LOCATION WHERE FOOD AND/OR BEVERAGES ARE PREPARED, MUST BE SMOOTH, EASILY CLEANABLE, NON ABSORBENT, AND DURABLE. WALLS AND CEILINGS ARE TO BE LIGHT COLORED.
- 4. CONSTRUCT PARTITION WALLS BETWEEN KITCHEN AREAS AND PUBLIC AREAS FOR MAXIMUM SOUND CONTROL.
- 5. PROVIDE FLOOR LOADING CAPACITY AT A MINIMUM OF 150 POUNDS PER SQUARE FOOT OR AS REQUIRED BY LOCAL CODES OR SPECIAL EQUIPMENT REQUIREMENTS.

6. MINIMUM VENTILATION REQUIREMENTS: A. KITCHEN, SERVICE, PREPARATION, AND WAREWASHING AREAS - 5 TO 6 CHANGES EVERY HOUR. B. STOREROOMS - 2 TO 3 CHANGES PER HOUR.

- C. OFFICES 4 AIR CHANGES PER HOUR (AIR CONDITIONING RECOMMENDED).D. REFRIGERATION CONDENSING UNITS: AIR COOLED 650 CFM PER H.P.; WATER COOLED 200 CFM PER H.P. SUPPLY AND EXHAUST.
- E. OTHER AREAS AS REQUIRED BY CODE OR AS NOTED.
- 7. VERIFY THAT VENTILATION REQUIREMENTS SHOWN ARE IN COMPLIANCE WITH LOCAL CODES.

CONDUITS AT WALL/FLOOR PENETRATIONS AS REQUIRED FOR REFRIGERATION PIPING.

- 8. FINAL DUCT CONNECTIONS ARE BY MECHANICAL CONTRACTOR.
- ROUGH-IN/CONNECTION HEIGHTS NOTED ON THE MECHANICAL CONNECTION SCHEDULE INDICATE HEIGHT ABOVE FINISHED FLOOR (A.F.F.)
 GENERAL CONTRACTOR, OR EQUIVALENT, SHALL FURNISH AND INSTALL THE FOLLOWING:
- A. HEAVY GAUGE METAL STUDS IN ALL FOODSERVICE AREA WALLS.
 B. IN-WALL REINFORCING OR BACKING (- -) AS REQUIRED FOR WALL MOUNTED KITCHEN EQUIPMENT, COORDINATE SIZE, MOUNTING HEIGHTS AND INSTALLATION REQUIREMENTS WITH F.E.C. MOUNT ALL SHELVES AT 54" AND 66" -A.F.F., UNLESS OTHERWISE NOTED. MOUNT HAND SINKS (PROVIDED BY PLUMBING CONTRACTOR), AT 36"-A.F.F.
 C. SLOPE FLOORS TO FLOOR DRAINS, AND FLOOR TROUGHS.
- D. PROVIDE DOOR/WALL OPENINGS AND/OR PASSAGES TO ASSURE ACCESS FOR ALL KITCHEN EQUIPMENT. COORDINATE SIZES WITH F.E.C.
 E. PROVIDE WALK-IN REFRIGERATION DEPRESSIONS, SMOOTH AND TRANSIT LEVEL, WHERE DEPRESSIONS ARE REQUIRED. DEPTH AS NOTED. COORDINATE REQUIREMENTS WITH F.E.C.
 F. FILL EXCESS DEPRESSIONS AROUND WALK-INS, FLOOR TROUGHS, WITH GROUT, FINISHED FLOOR, AND MATCHING COVED BASE AFTER WALK-INS AND FLOOR TROUGHS
- HAVE BEEN INSTALLED BY F.E.C.

 G. PROVIDE MASONRY PADS, WHEN SHOWN, WITH TROWEL SMOOTH AND LEVEL FINISH.

 H. PROVIDE FIRE-RATED MATERIALS AND/OR INSULATION AS REQUIRED FOR EXHAUST DUCTS, VENT STACKS, PORTION OF EXHAUST HOODS ABOVE CEILING HEIGHT, HEAT PRODUCING EQUIPMENT, ROOF/WALL PENETRATIONS, ETC.; PER LOCAL CODES.

 I. PROVIDE COVED BASE MOLDING OR COVED INTEGRAL FLOOR MATERIALS AS REQUIRED AT ALL VERTICAL SURFACES WHERE THEY MEET FLOORS IN FOODSERVICE AREAS. J. PROVIDE SLEEVES OR

FOOD BANK OF THE ROCKIES

698 LONG ACRE DRIVE GRAND JUNCTION, COLORADO


BUILDING CONDITIONS & VENTILATION PLAN

NO:	ISSUED FOR:	DATE:
	ADDENDUM #9	9/15/202
^		

100% CONSTRUCTION DOCUMENTS

DATE: 8/25/2021 SHEET NO:

FS1.2

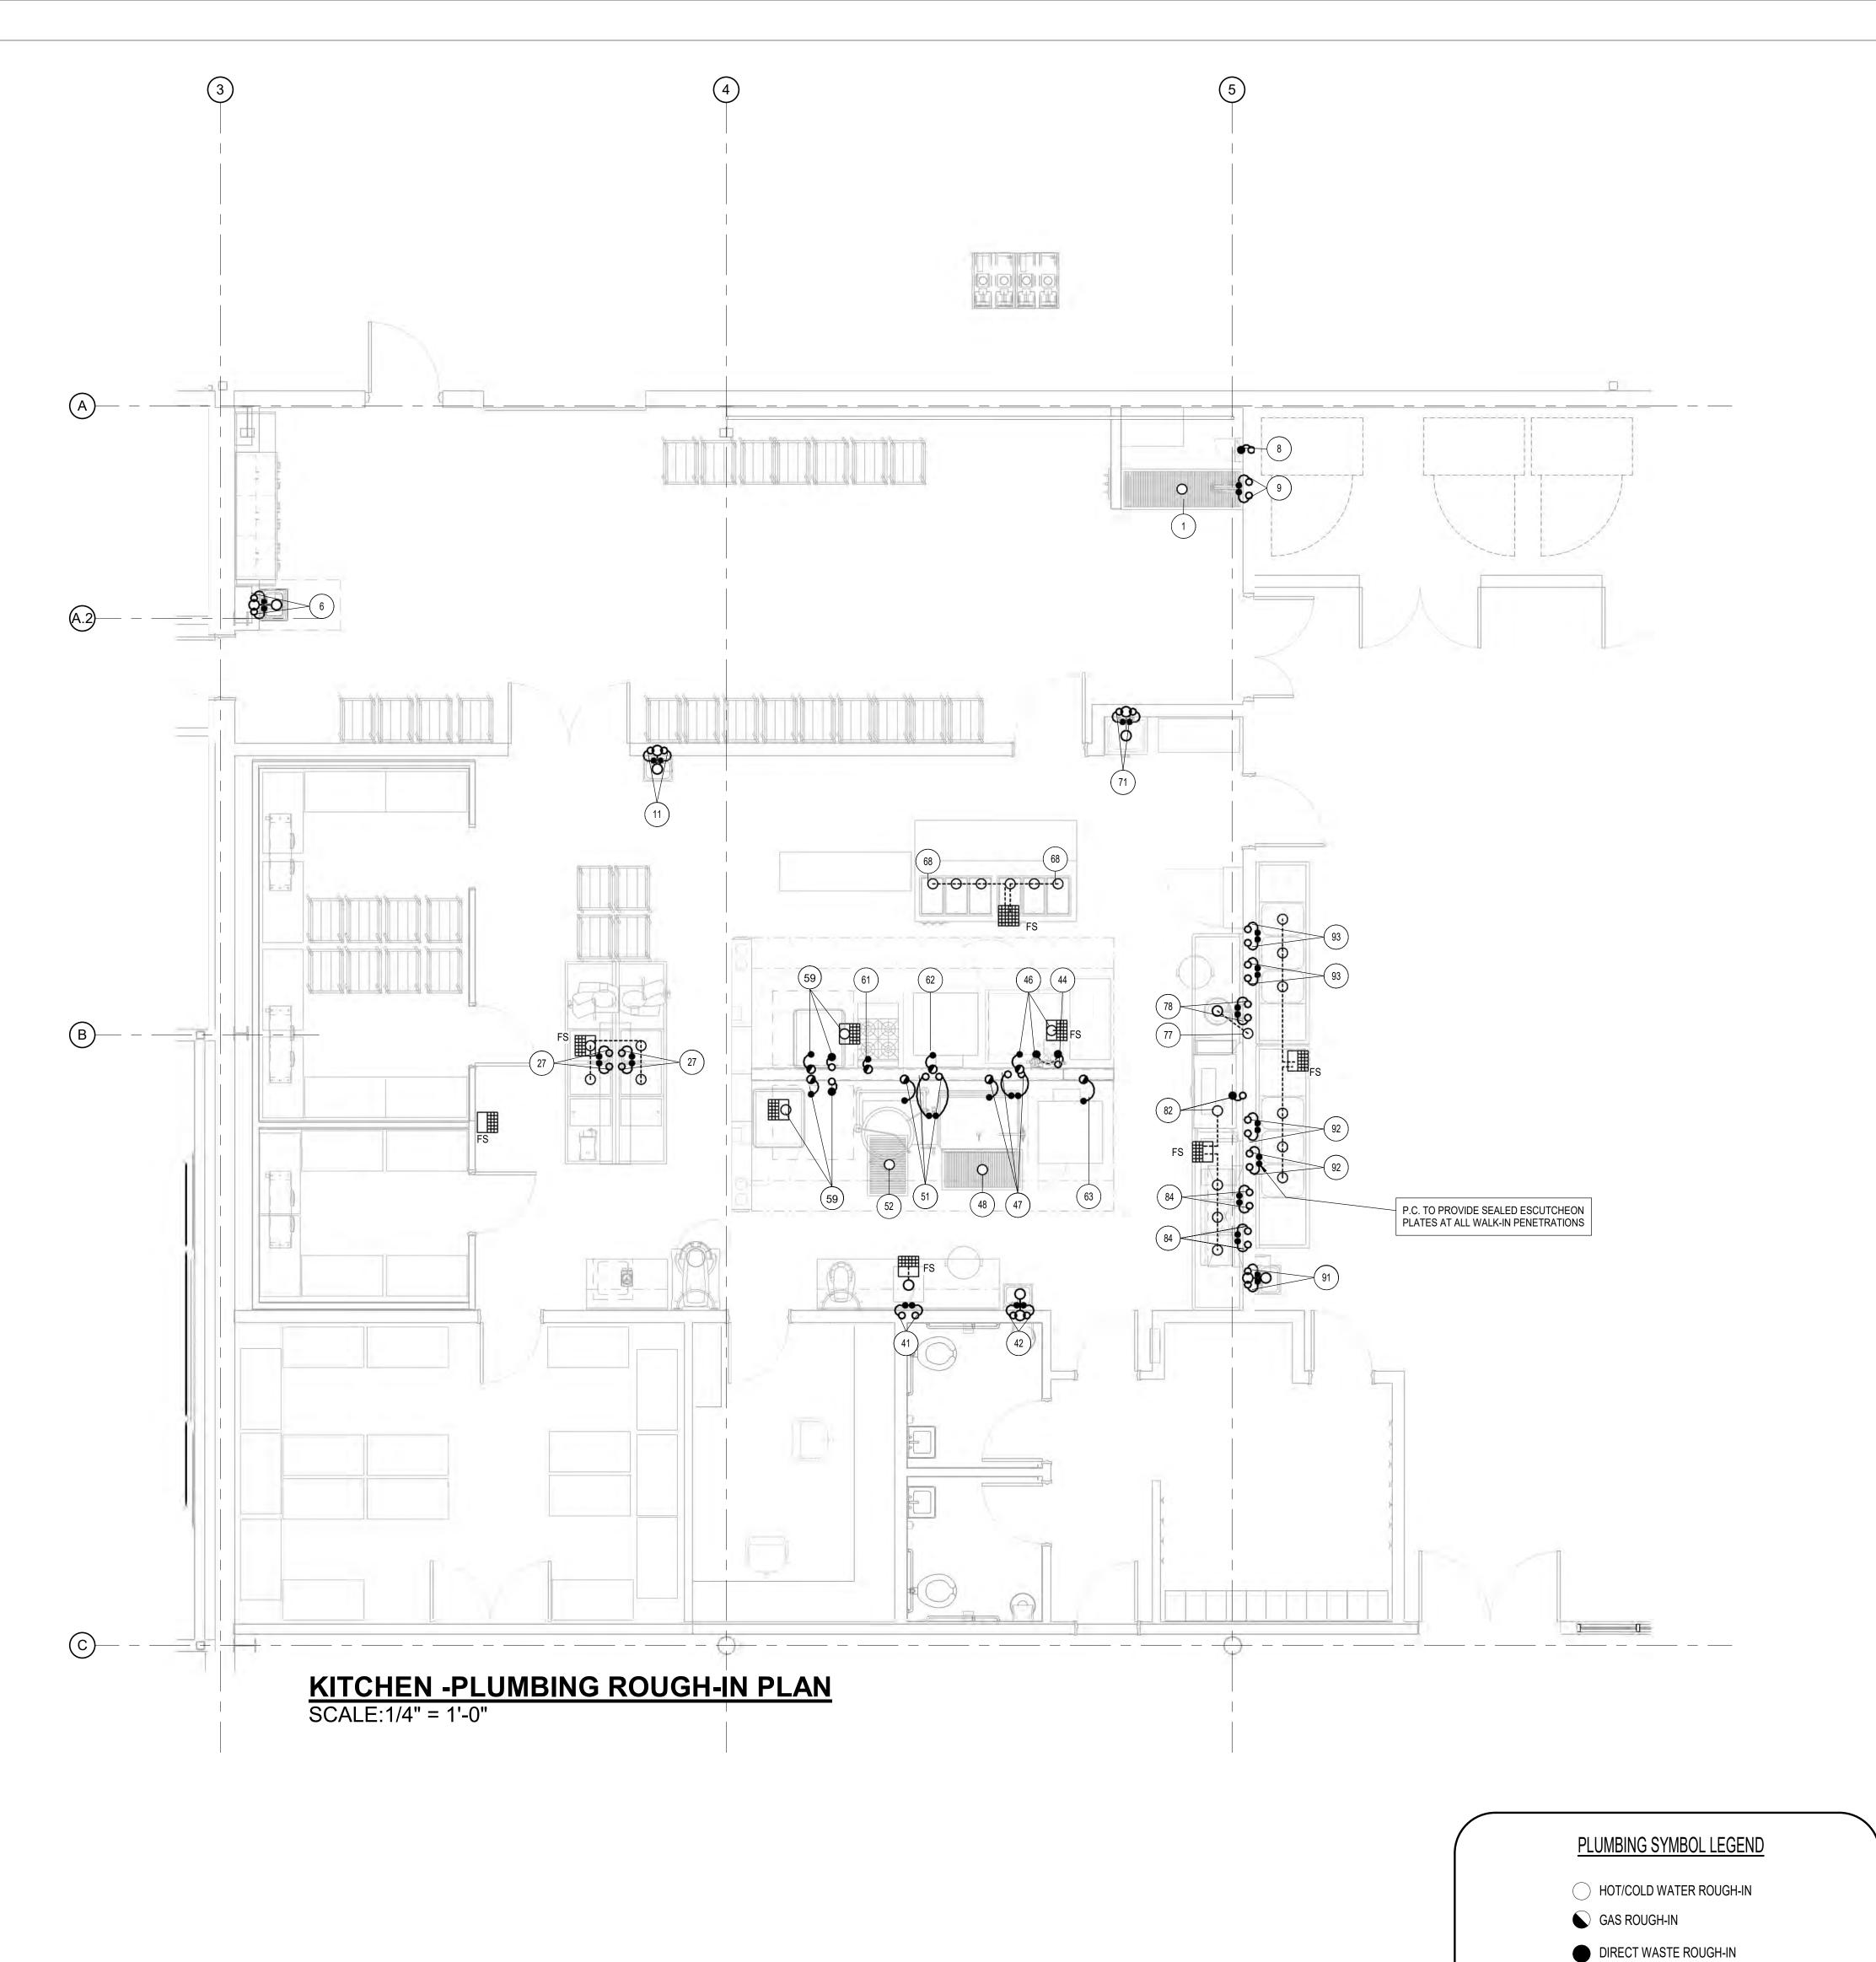

ALL WORK ON THIS SHEET SHALL BE PROVIDED (FURNISHED AND INSTALLED) IN THIS CONTRACT, INLCUDING MECHANICAL, PLUMBING, AND ELECTRICAL ROUGH-IN. ALL FLOOR DRAINS, FLOOR SINKS AND FLOOR TROUGHS SHALL BE PROVIDED UNDER THIS CONTRACT.

PLUMBING GENERAL NOTES

* E.C. TO INTER-WIRE COIL AND CONDENSER DEFROST SYSTEM IN W/ FREEZER REF. SYSTEMS.

* E.C. TO MOUNT AND WIRE LIGHTS, SWITCHES, AND PROVIDE/INSTALL LAMPS IN WALK-IN COOLERS/FREEZERS

* E.C. TO CONNECT FAN AND LIGHTS WITH HOOD SWITCHES AND PROVIDE LAMPS.

* E.C. TO CONNECT FAN AND LIGHTS WITH HOOD SWITCHES AND PROVIDE LAMPS.

* E.C. TO INTER-WIRE DISPOSER AND CONTROL PANEL FROM E.C.- PROVIDED DISCONNECT.

* ALL "BY PURVEYOR", "BY OPERATOR", OR "EXISTING" EQUIPMENT MECHANICAL, ELECTRICAL, AND PLUMBING INFORMATION SHOULD BE VERIFIED PRIOR TO CONSTRUCTION

* P.C. TO FURNISH AND INSTALL BRASS BALL VALVES/STOPS IN PIPE SIZE INDICATED TO ALL HOT AND COLD

CONNECTIONS ON ALL FS EQUIPMENT SHOWN.

* POLICIA IN DIMENSIONS AND DETAILS ARE FOR REFERENCE ONLY. REFER TO F.E.C. SUBMITTALS FOR FIN

* ROUGH-IN DIMENSIONS AND DETAILS ARE FOR REFERENCE ONLY - REFER TO F.E.C. SUBMITTALS FOR FINAL ROUGH-IN DETAILS AND LOCATIONS.

PLUMBING ROUGH-IN PLAN NOTES

THE INFORMATION CONTAINED ON THIS DRAWING IS COORDINATED WITH THE ARCHITECT AND ENGINEERS.

CONTRACTORS SHALL VERIFY LOCATIONS OF ROUGH-INS AND SERVICE REQUIREMENTS WITH FIELD DIMENSIONS AND

CONDITIONS. COORDINATE INSTALLATION REQUIREMENTS OF FOOD / BEVERAGE EQUIPMENT WITH THE FOODSERVICE

EQUIPMENT CONTRACTOR (F.E.C.). EQUIPMENT DESIGNATED BY NOTE "NIFSC" IS DEFINED AS "NOT IN FOODSERVICE CONTRACT".

ALL ROUGH-INS AND CONNECTIONS SHOWN RELATE TO FOODSERVICE FIXTURES AND EQUIPMENT ONLY. SEE ARCHITECTURAL / ENGINEERING PLANS FOR ADDITIONAL PLUMBING REQUIREMENTS.

2. THIS PLUMBING PLAN IS INTENDED TO SHOW PRELIMINARY ROUGH-IN LOCATIONS AND HEIGHTS, CONNECTION SIZES AND LOAD REQUIREMENTS. SEE F.E.C. DIMENSIONED PLANS FOR FINAL LOCATIONS.

3. FINAL CONNECTIONS TO ALL FOODSERVICE EQUIPMENT SHALL BE BY THE PLUMBING CONTRACTOR, INCLUDING REQUIRED MATERIALS, SUCH AS, BUT NOT LIMITED TO, STOPS, VALVES, FILTERS, TRAPS, CHECK VALVES, PIPING, TUBING, ETC. UNLESS OTHERWISE NOTED. P.C. SHALL FURNISH BRASS BALL VALVE STOPS TO ALL H/C WATER CONNECTIONS IN ACCORD WITH SIZE OF FEED PIPE.

4. ROUGH-IN HEIGHTS NOTED ON THE PLUMBING SCHEDULE INDICATE HEIGHT ABOVE FINISHED FLOOR (A.F.F.)

5. PLUMBING CONTRACTOR SHALL FURNISH AND INSTALL THE FOLLOWING:

A. ALL WATER, WASTE, GAS, STEAM, AND AIR SERVICE FROM THE POINT OF ROUGH-IN TO THE FOODSERVICE FIXTURE

AND EQUIPMENT ITEMS AS SHOWN ON THE PLAN. ROUGH-IN OUTLETS TO STUB 2" OUT OF WALLS AT HEIGHT INDICATED

TO CENTERLINE OF OUTLET. FLOOR ROUGH-INS TO STUB UP 4" (100 mm) A.F.F. OR CURB. ALL FLOOR OPENINGS AND/OR
PENETRATIONS SHALL BE WATER TIGHT.

B. PRESSURE REDUCING AND/OR REGULATING VALVES FOR, BUT NOT LIMITED TO, WAREWASHERS, BOOSTER HEATERS, AND AS OTHERWISE NOTED, IN FOODSERVICE AREAS.
 C. ALL FLOOR SINKS, COMPLETE WITH THREE QUARTER GRATES, UNLESS OTHERWISE NOTED, AND REMOVABLE SEDIMENT BUCKETS SET FLUSH WITH FINISHED FLOOR, UNLESS OTHERWISE NOTED OR REQUIRED BY CODE.

D. ALL WASTE LINES, DIRECT AND INDIRECT, EXCEPT AS NOTED OTHERWISE. MINIMUM DIAMETER OF LINES SHALL BE
AS NOTED IN THE PLUMBING CONNECTION SCHEDULE, REGARDLESS OF CONNECTION SIZE, AND SHALL BE PITCHED
DOWNWARD. MAINTAIN DRAINS AS HIGH AS POSSIBLE ABOVE FINISHED FLOOR. PROVIDE CLEAN-OUTS ON ALL WASTE
LINES.
 E. INDIRECT WASTE LINES FOR WALK-IN REFRIGERATED BOXES SHALL BE PITCHED A MINIMUM OF 1/4" PER FOOT WITH

A "P" TRAP AT END OVER FLOOR SINK. PIPING ON EXTERIOR SHALL BE PARALLEL TO WALK-IN. PENETRATE WALK-IN WALL WITH WASTE LINE AT 1'-0" (300 mm) A.F.F.

F. HOT WATER SUPPLY TO WAREWASHERS, BOOSTER HEATERS, AND WATER WASH EXHAUST HOODS, SHALL BE A MINIMUM OF 140 DEGREES FAHRENHEIT

MINIMUM OF 140 DEGREES FAHRENHEIT.

G. ALL REQUIRED GREASE TRAPS, SHALL BE OUTSIDE THE BUILDING IF AT ALL POSSIBLE, OTHERWISE, FLUSH WITH FLOOR.
H. INSTALL FIRE PROTECTION SYSTEM GAS SHUT-OFF VALVE(S), FURNISHED BY THE FIRE PROTECTION SYSTEM

H. INSTALL FIRE PROTECTION SYSTEM GAS SHUT-OFF VALVE(S), FURNISHED BY THE FIRE PROTECTION SYSTEM CONTRACTOR, WHEN GAS COOKING EQUIPMENT IS USED.

I. VACUUM BREAKERS AND BACK FLOW PREVENTION DEVICES AS REQUIRED BY LOCAL CODE.

J. INSULATION ON ALL STEAM, HOT WATER, AND CONDENSATE LINES, IN THE FOODSERVICE AREAS. INSULATION SHALL

J. INSULATION ON ALL STEAM, HOT WATER, AND CONDENSATE LINES, IN THE FOODSERVICE AREAS. INSULATION S HAVE HARD, SMOOTH CLEANABLE COVER. ALL SUCH LINES SHALL BE COLOR CODED IN ACCORDANCE WITH APPLICABLE CODES.
K. CLEAN-OUTS FOR STEAM, CONDENSATE, AIR, AND DRAIN LINES.

L. INTERCONNECT WAREWASHERS AND BOOSTER HEATERS AS PER MANUFACTURER'S INSTRUCTIONS.

STEAM SUPPLY

STEAM RETURN

FLOOR SINK - HALF GRATE

FLOOR SINK - FULL GRATE

FUNNEL TYPE FLOOR DRAIN

CHILLED WATER SUPPLY

□ CHILLED WATER RETURN

FIELD CONNECTIONS

FLOOR DRAIN

FLOOR SINK - 3 QUARTER GRATE

M. INTERCONNECT HOOD CONTROL PANEL(S) WITH EXHAUST HOOD(S) AS PER THE MANUFACTURERS INSTRUCTIONS.

N. AREA FLOOR DRAINS AS LOCATED AND SPECIFIED BY PLUMBING ENGINEER AND AS REQUIRED BY CODE.

O. HANDSINKS, MOP SINKS/ HOSE BIBS WITH MIXING VALVES AND BACK FLOW PREVENTION DEVICES AS INDICATED AND REQUIRED BY CODE.

REQUIRED BY CODE.

P. ALL INTERCONNECTIONS OF FOODSERVICE EQUIPMENT AND FIXTURES DELIVERED TO THE JOB SITE IN SECTIONS.

Q. ASSEMBLE AND CONNECT ALL LINES FURNISHED BY F.E.C. AS PART OF THE UTILITY DISTRIBUTION SYSTEM(S) TO INDIVIDUAL ITEMS OF EQUIPMENT.

6. CONCEAL ALL VENT PIPES IN WALLS OR COLUMN CHASES. USE LOOP-VENTS FOR ISLAND FIXTURES.
7. ALL EXPOSED PIPING AND FITTINGS IN FOODSERVICE AREAS SHALL BE PAINTED WITH SEYMORE 16-054 STAINLESS STEEL PAINT (800-435-4482) UNLESS SPECIFIED IN OTHER SECTIONS TO BE CHROME PLATED, OR STAINLESS STEEL.

8. ROUTE ALL LINES THROUGH EQUIPMENT SO AS NOT TO INTERFERE WITH THE INTENDED USE OF, OR SERVICING OF THE EQUIPMENT.

9. ALL WASTE LINES SHOWN ON THIS DRAWING ARE DESIGNED TO COMPLY WITH GENERALLY ACCEPTED HEALTH AND SANITARY CONDITIONS AND CODES. PLUMBING ENGINEER/CONTRACTOR IS RESPONSIBLE FOR VERIFYING COMPLIANCE WITH LOCAL

HEALTH AND BUILDING CODES AND MAKING ALL ADJUSTMENTS AS REQUIRED.

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FOOD BANK OF THE ROCKIES

698 LONG ACRE DRIVE GRAND JUNCTION, COLORADO

PLUMBING ROUGH-IN PLAN


NO:	ISSUED FOR:	DATE:
	ADDENDUM #9	9/15/202

100% CONSTRUCTION DOCUMENTS

DATE: **8/25/2021** SHEET NO:

PROJECT NO:

FS1.3

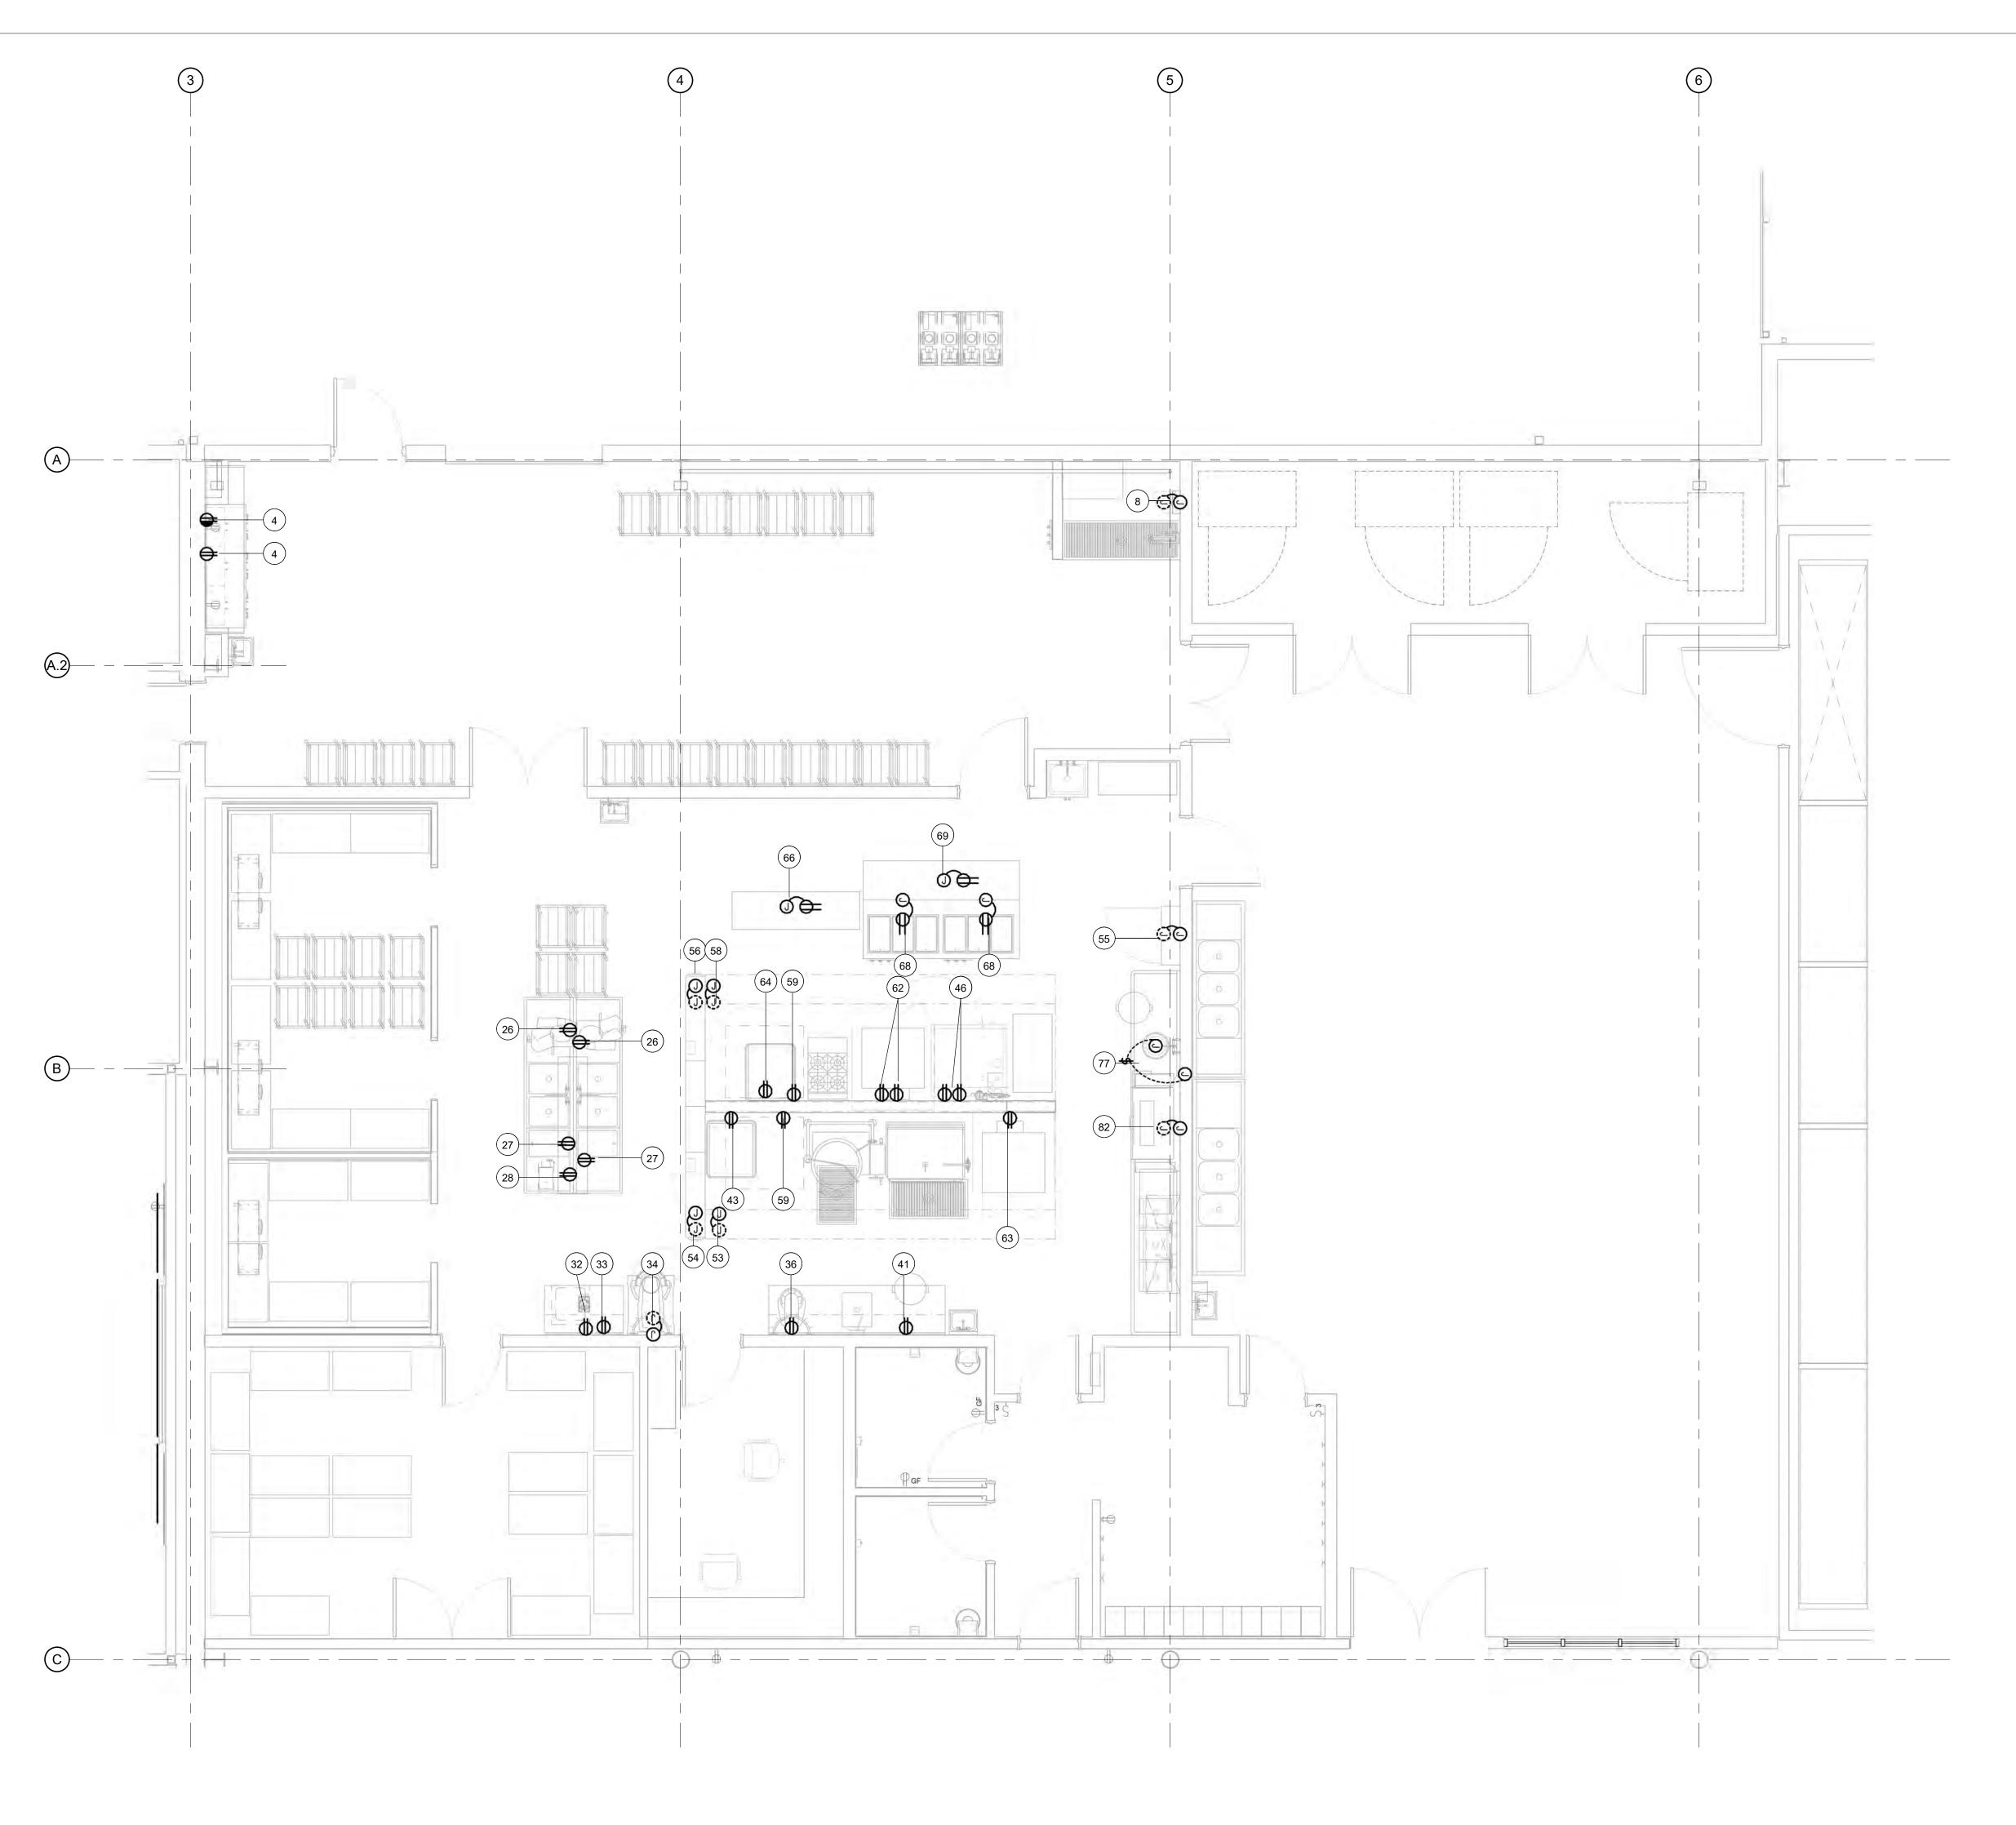

KITCHEN - ELECTRICAL ROUGH-IN PLAN SCALE: 1/4" = 1'-0"

ELECTRICAL GENERAL NOTES

- * E.C. TO INTER-WIRE COIL AND CONDENSER DEFROST SYSTEM IN W/ FREEZER REF. SYSTEMS.

 * E.C. TO MOUNT AND WIRE LIGHTS, SWITCHES, AND PROVIDE/INSTALL LAMPS IN WALK-IN COOLERS/FREEZERS

 * E.C. TO CONNECT FAN AND LIGHTS WITH HOOD SWITCHES AND PROVIDE LAMPS.
- * E.C. TO INTER-WIRE DISPOSER AND CONTROL PANEL FROM E.C.- PROVIDED DISCONNECT.
- *ALL "BY PURVEYOR", "BY OPERATOR", OR "EXISTING" EQUIPMENT MECHANICAL, ELECTRICAL, AND PLUMBING
- INFORMATION SHOULD BE VERIFIED PRIOR TO CONSTRUCTION

 * P.C. TO FURNISH AND INSTALL BRASS BALL VALVES/STOPS IN PIPE SIZE INDICATED TO ALL HOT AND COLD CONNECTIONS ON ALL FS EQUIPMENT SHOWN.

* ROUGH-IN DIMENSIONS AND DETAILS ARE FOR REFERENCE ONLY - REFER TO F.E.C. SUBMITTALS FOR FINAL ROUGH-IN DETAILS AND LOCATIONS.

ALL ELECTRICAL ROUGH-IN AND ALL WORK ON THIS SHEET SHALL BE PROVIDED UNDER THIS CONTRACT.

ELECTRICAL SYMBOL LEGEND

- WALL MOUNTED DUPLEX RECEPTACLE
 120 VOLT, GROUND TYPE
- WALL MOUNTED SIMPLEX RECEPTACLE
- 120 VOLD, GROUND TYPE

 WALL MOUNTED SPECIAL PURPOSE OUTLET

CEILING MOUNTED RECEPTACLE

- 208 VOLT, GROUND TYPEWALL MOUNTED SPECIAL PURPOSE OUTLET
- 480 VOLT, GROUND TYPE
- 120 VOLT, GROUND TYPE
- FLOOR MOUNTED RECEPTACLE 120 VOLT, GROUND TYPE
- FLOOR MOUNTED RECEPTACLE 208 VOLT, GROUND TYPE
- JUNCTION BOX
- DROP CORD SPECIAL PURPOSE OUTLET 208 VOLT, GROUND TYPE
- DROP CORD, DUPLEX RECEPTACLE
 120 VOLT, GROUND TYPE, DROPPED TO 6'-6" A.F.F.
- DISCONNECT BOX
- \$ SWITCH
- -**v** VAPOR-PROOF LIGHT
- WALK-IN TEMPERATURE ALARM
- □ DATA AND TELEPHONE CONNECTION
- FIELD WIRING

ELECTRICAL ROUGH-IN PLAN NOTES

- THE INFORMATION CONTAINED ON THIS DRAWING IS COORDINATED WITH THE ARCHITECT AND ENGINEERS. CONTRACTORS SHALL VERIFY LOCATION OF ROUGH-INS AND SERVICE REQUIREMENTS WITH FIELD DIMENSIONS AND CONDITIONS. COORDINATE INSTALLATION REQUIREMENTS OF FOOD/BEVERAGE SERVICE EQUIPMENT WITH FOODSERVICE EQUIPMENT CONTRACTOR (F.E.C.) EQUIPMENT DESIGNATED ON PLAN BY NOTE NIFSC IS DEFINED AS "NOT IN FOODSERVICE CONTRACT".
- . ELECTRICAL SYSTEM IS DESIGNED FOR 120/208 VOLTS, 3 PHASE, 4 WIRE, 60 HERTZ, UNLESS OTHERWISE NOTED.
- 2. ALL ROUGH-INS AND CONNECTIONS SHOWN RELATE TO FOODSERVICE EQUIPMENT AND FIXTURES ONLY. SEE ARCHITECTURAL/ENGINEERING PLANS FOR ADDITIONAL ELECTRICAL REQUIREMENTS. E.C. TO COORDINATE WITH F.E.C. PRIOR TO CONSTRUCTION FOR VERIFICATION OF REQUIRED CIRCUITRY.
- THIS ELECTRICAL PLAN IS INTENDED TO SHOW OUTLET TYPES, LOCATIONS, AND CONNECTION POSITIONS AND LOADS. FOR FINAL ROUGH-IN LOCATIONS, SEE F.E.C. DIMENSIONED PLANS. DIMENSIONS, WHEN SHOWN, ARE FROM COLUMN CENTERS, FINISHED FLOORS,
- ROUGH-IN LOCATIONS, SEE F.E.C. DIMENSIONED PLANS. DIMENSIONS, WHEN SHOWN, ARE FROM COLUMN CENTERS, FINISHED FLOORS, AND FINISHED WALLS.

 ALL ELECTRICAL WORK FOR FABRICATED FOODSERVICE EQUIPMENT AND FIXTURES, SHALL BE COMPLETELY PRE-WIREDBY THE F.E.C. TO A JUNCTION-BOX OR PULL-BOX MOUNTED ON THE EQUIPMENT, IN AN ACCESSIBLE POSITION. FINAL CONNECTIONS TO THE
- 5. FINAL CONNECTIONS TO ALL FOODSERVICE EQUIPMENT AND FIXTURES SHALL BE BY THE ELECTRICAL CONTRACTOR, INCLUDING ALL LABOR AND MATERIALS.

FOODSERVICE FIXTURES AND EQUIPMENT JUNCTION BOXES OR PULL BOXES, AND ALL ELECTRICAL WORK FROM PANEL BOXES SHALL

- ROUGH-IN/CONNECTION HEIGHTS NOTED IN THE ELECTRICAL CONNECTION SCHEDULE ARE ABOVE FINISHED FLOOR(A.F.F.) TO THE CENTER OF THE OUTLET. ALL OUTLETS SHALL BE MOUNTED HORIZONTALLY.
- ELECTRICAL CONTRACTOR SHALL FURNISH AND INSTALL THE FOLLOWING:

 A. ALL JUNCTION BOXES, ELECTRICAL OUTLETS, COVER PLATES, SWITCHES, ETC., NOT BUILT INTO THE EQUIPMENT AND FIXTURES. ALL OUTLETS, JUNCTION BOXES, COVER PLATES, ETC., IN DISHROOMS AND OTHER HIGH MOISTURE AREAS, OR AS INDICATED IN
- SCHEDULES, SHALL BE VAPOR PROOF.

 B. SHUNT TRIP CIRCUIT BREAKERS OR DISCONNECTS FOR FIRE PROTECTION SYSTEM, SHUT-OFF OF ALL FOODSERVICE EQUIPMENT. ELECTRICAL CIRCUITS LOCATED BENEATH EXHAUST HOODS AS REQUIRED BY N.F.P.A. AND APPLICABLE CODES.

 C. DISCONNECTS OR OTHER DEVICES AS REQUIRED BY LOCAL CODES UNLESS OTHERWISE NOTED.
- 8. ELECTRICAL CONTRACTOR SHALL PROVIDE CIRCUIT(S) CONDUIT AND WIRING, INSTALL ELECTRICAL COMPONENTS (PROVIDED BY F.E.C.)
- AND INTERWIRE BETWEEN THE FOLLOWING:
 A. REMOTE REFRIGERATION EQUIPMENT AND EVAPORATOR COILS.
 B. CONTROL PANELS TO WATER WASH EXHAUST HOODS AND EXHAUST/SUPPLY FAN MAGNETIC STARTERS PER MANUFACTURERS
- INSTRUCTION.
 C. FOODSERVICE EXHAUST HOODS TO FIRE PROTECTION SYSTEM AND SHUT-OFFS.
- C. POODSERVICE EXHAUST HOODS TO FIRE PROTECTION SYSTEM AND SHOT-OFFS.

 D. DISPOSALS, SOLENOID VALVES, AND CONTROL PANELS.

 E. FOOD SERVICE EXHAUST HOOD LICHTS AND SWITCHES IF SUBBLIED. F.C. TO PROVIDE LAMBS
- E. FOOD SERVICE EXHAUST HOOD LIGHTS AND SWITCHES IF SUPPLIED. E.C. TO PROVIDE LAMPS.F. ALL INTERCONNECTIONS OF FOODSERVICE EQUIPMENT AND FIXTURES DELIVERED TO THE JOB SITE IN SECTIONS.
- G. ASSEMBLE AND CONNECT ALL LINES FURNISHED BY THE F.E.C. AS PART OF THE UTILITY DISTRIBUTION SYSTEM(S) TO INDIVIDUAL ITEMS OF EQUIPMENT.
 H. ALL OTHER FOODSERVICE EQUIPMENT AND FIXTURES ITEMS WITH COMPONENTS SHIPPED LOOSE BY THE MANUFACTURER OR F.E.C.
 9. WALK-IN COOLERS/FREEZERS:
- A. LIGHTS, INCLUDING NIGHT LIGHTS, THERMOMETER/TEMPERATURE ALARMS, FREEZER DOOR SWITCHES, DOOR FRAME HEATERS, FREEZER HEATED RELIEF PORTS, REMOTE DOOR SWITCHES, FURNISHED BY F.E.C. INSTALLED AND WIRED BY THE ELECTRICAL CONTRACTOR. ALL CONDUIT SHALL BE RUN ON THE EXTERIOR TOP OF THE WALK-IN.
 B. DISCONNECTS, SWITCHES AT EVAPORATOR COILS AND AN ADJACENT VAPOR-PROOF CONVENIENCE OUTLETS AND DRAIN LINE HEAT TAPE FURNISHED AND INSTALLED BY ELECTRICAL CONTRACTOR.
- 10. CONVENIENCE OUTLETS SHOWN ARE FOR FOODSERVICE EQUIPMENT AND FIXTURES OPERATION. ADDITIONAL AREA CONVENIENCE
 OUTLETS SHALL BE FURNISHED AND INSTALLED BY ELECTRICAL CONTRACTOR AS LOCATED ON THE ELECTRICAL ENGINEERING PLANS.

C. INTERCONNECTIONS OF ELECTRICAL COMPONENTS OF ALL WALK-IN COOLERS/FREEZERS AND COMPRESSORS BY ELECTRICAL

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FOOD BANK OF THE ROCKIES

698 LONG ACRE DRIVE GRAND JUNCTION, COLORADO

ELECTRICAL ROUGH-IN PLAN


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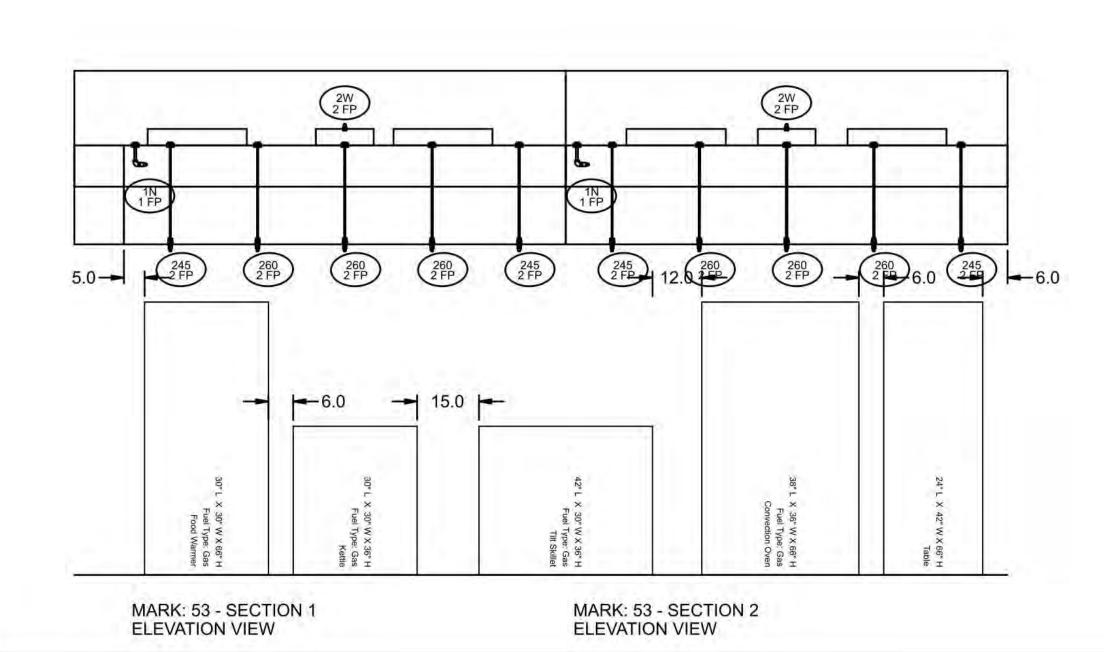
ADDENDUM #9 9/15/2021

100% CONSTRUCTION DOCUMENTS

DATE: SHEET NO:

PROJECT NO: FS1.



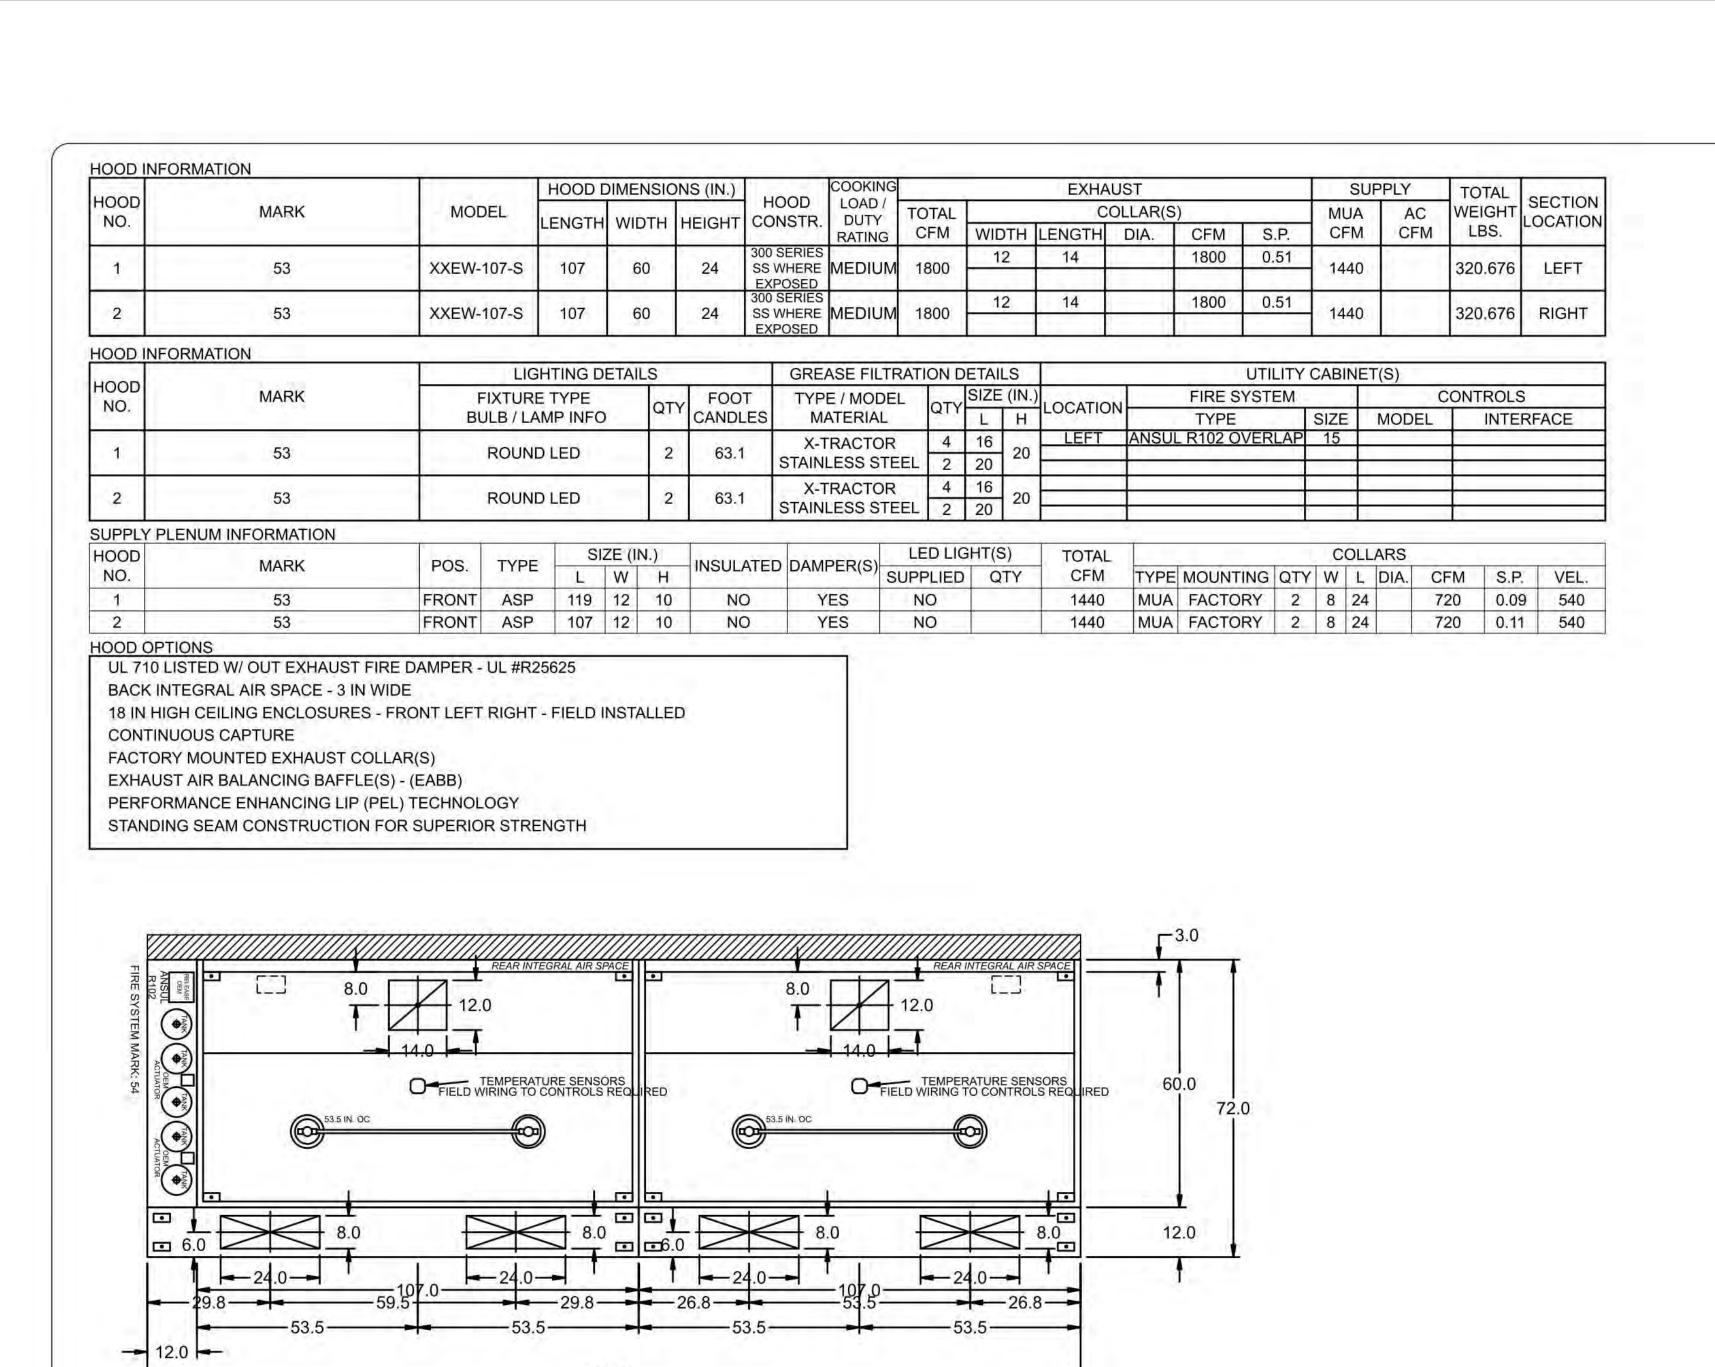



MARK: 53 - SECTION 1

PLAN VIEW

MARK: 53 - SECTION 2

PLAN VIEW

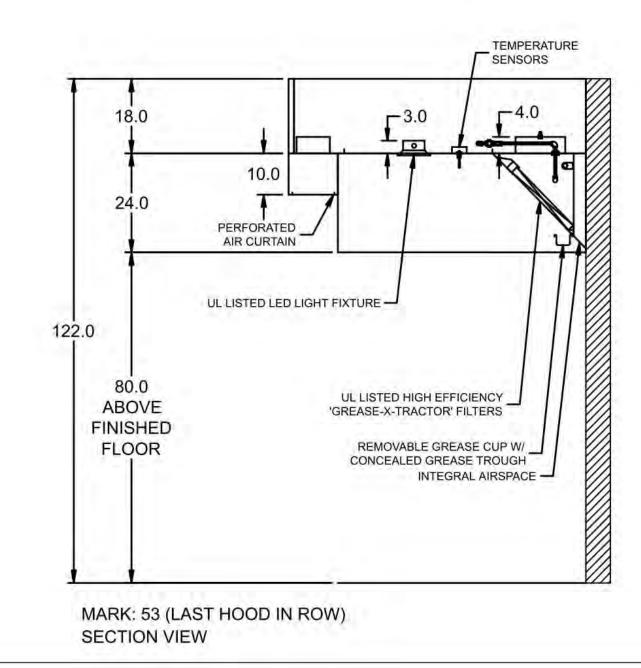

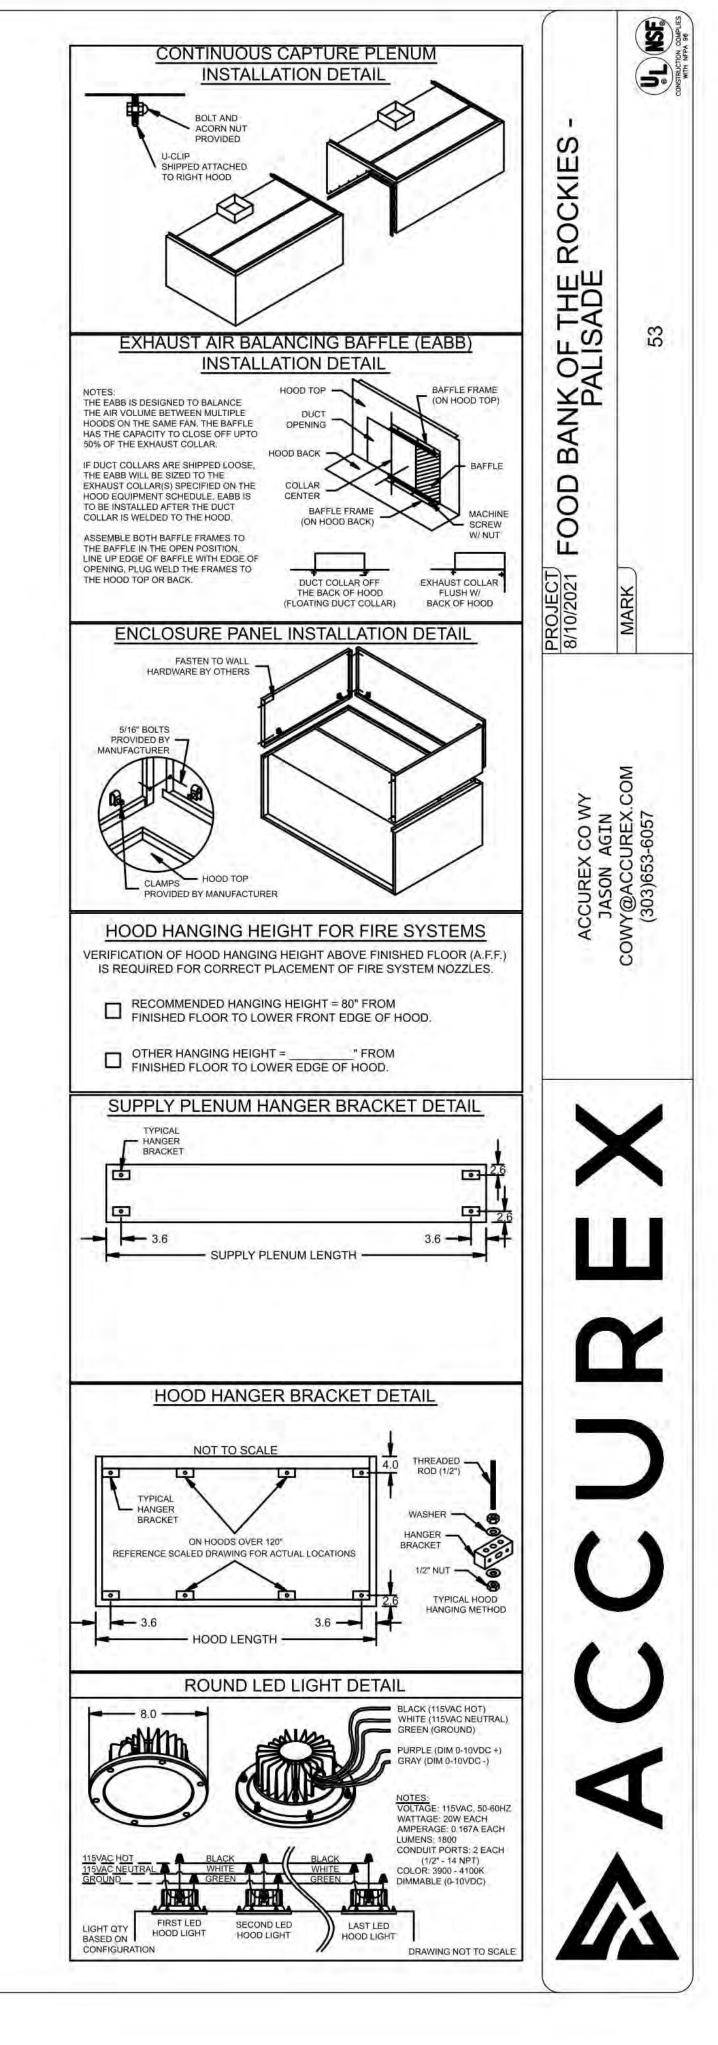

THE KITCHEN HOOD ASSEMBLY, FIRE SUPPRESSION SYSTEM,
CONTROLS AND RELATED ACCESSORIES AS SHOWN OR SPECIFIED
OR REQUIRED FOR COMPLETE AND FUNCTIONAL SYSTEM SHALL BE
PROVIDED (FURNISHED AND INSTALLED) UNDER THIS CONTRACT.

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698 LONG ACRE DRIVE GRAND JUNCTION, COLORADO

HOOD DETAIL

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9/15/20

100% CONSTRUCTION DOCUMENTS

DATE: **8/25/2021**

SHEET NO:

FS2.0

FIRE SYSTEM INFORMATION

MADIC	MODEL	LOCATION	FLOW P	OINTS	SUPPLY	DETECTION	MARK(S) PROTECTED BY FIRE SYSTEM
MARK	MODEL	LOCATION	HOODS	PCU	LINE	DETECTION	WARK(S) FROTECTED BY FIRE STSTEM
F4	ANSUL R-102	CARINET LEET END OF 52	26 UTILIZED		CONTINUOUS	FUOIDI E LINIZ	53 SECTION 1
54	OVERLAPPING WET CHEMICAL	CABINET – LEFT END OF 53	30 AVAILABLE		CONTINUOUS	FUSIBLE LINK	53 SECTION 2

FIRE SYSTEM OPTIONS AND ACCESSORIES

FULL INSTALLATION (INCLUDES PRE-PIPED HOOD(S) WITH DETECTION AND FACTORY COORDINATED INSTALL)

CHROME SLEEVES FOR FACTORY PROVIDED APPLIANCES DROPS - INCLUDED


OVERLAPPING PROTECTION TYPE - FULL HOOD


METAL BLOW-OFF CAPS - INCLUDED


GAS VALVE - INCLUDED - MECHANICAL SHUTOFF VALVE, 2", (ANSUL) - PART# ANSULMECHSHUTOFFVALVE200

HOOD SUPPRESSION TANK - INCLUDED - 15 GAL. - [(5) 3.0 TANK(S)]

REMOTE PULL STATION - STANDARD - FIELD INSTALLATION AT SINGLE POINT OF EGRESS

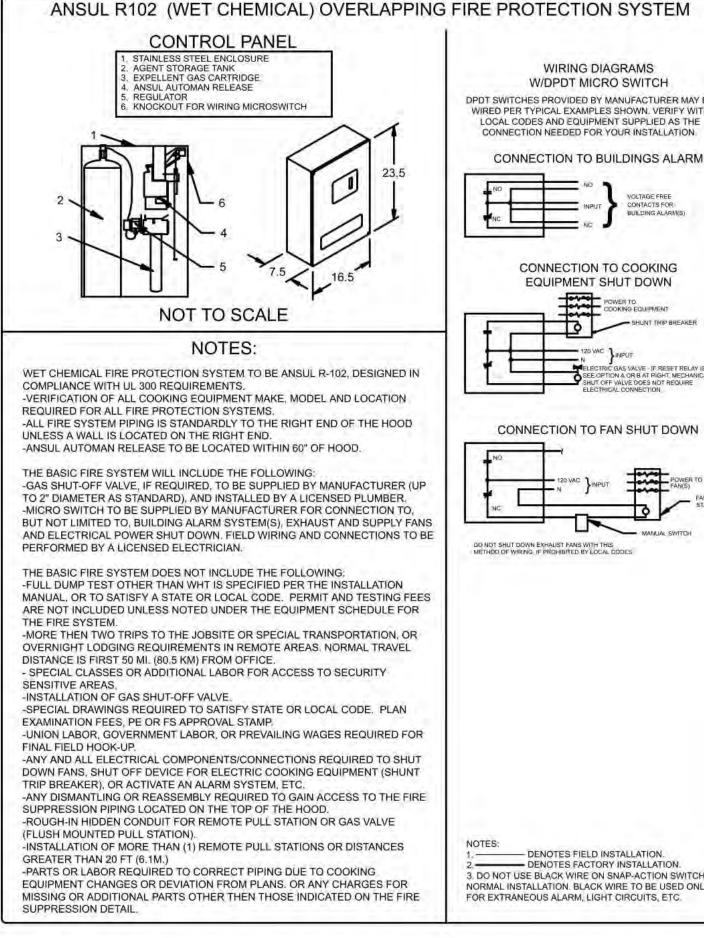

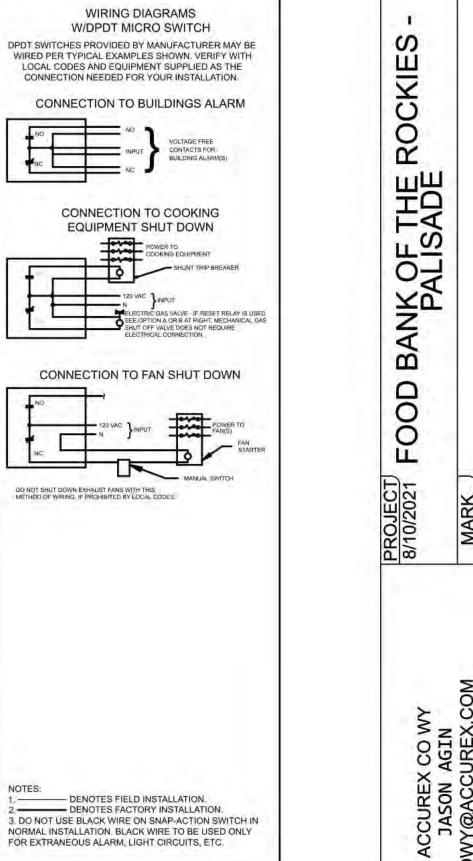

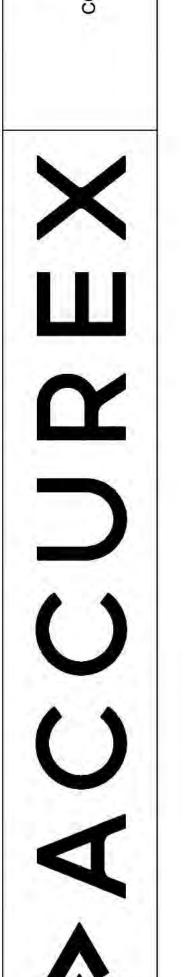

ADD #9 THE KITCHEN HOOD ASSEMBLY, FIRE SUPPRESSION SYSTEM, CONTROLS AND RELATED ACCESSORIES AS SHOWN OR SPECIFIED OR REQUIRED FOR COMPLETE AND FUNCTIONAL SYSTEM SHALL BE PROVIDED (FURNISHED AND INSTALLED) UNDER THIS CONTRACT.

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FOOD BANK OF THE ROCKIES

698 LONG ACRE DRIVE GRAND JUNCTION, COLORADO

HOOD DETAIL

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HOOD			HOOD	DIMENSI	ONS (IN.)	HOOD	COOKING				EXHA	UST			SI	JPPLY	TOTAL	CECTIO
HOOD NO.	MARK	MODEL	LENGTH	WIDTH	HEIGHT	HOOD CONSTR	LOAD / DUTY	TOTAL			C	OLLAR(S	S)		MUA		WEIGHT	SECTION LOCATION
			LENGIII	WIDITI	TILIOTTI	00,10,11,	RATING	CFM	WIE	HTC	LENGTH	DIA.	CFM	S.P.	CFM	CFM	LBS.	200/11/0
4	50	VVEW 407.0	407	00	0.4	300 SERIES		1000	1	2	14		1800	0.51	4440		200 070	Lecr
1	58	XXEW-107-S	107	60	24	SS WHERE EXPOSED	HEAVY	1800							1440		320.676	LEFT
2	350	VVEW 407.0	407	00	0.4	300 SERIES		1000	1	2	14	-	1800	0.51	4440		000.070	DIGUE
2	58	XXEW-107-S	107	60	24	EXPOSED	E HEAVY	1800							1440		320.676	RIGHT
HOOD IN	NFORMATION				****													
		LIC	SHTING D	ETAILS		GRE	ASE FILTRA	ATION E	ETAI	LS			100	UTILITY	CABINE	T(S)		
HOOD NO.	MARK	FIXTUR	E TYPE	07	F00	TYF	PE / MODEL	ОТУ	SIZE	(IN.)	LOCATIO	M	FIRE S	YSTEM		C	CONTROLS	3
NO.		BULB / L	AMP INFO	Q	CANDL	ES N	IATERIAL	QTY	L	H	LOCATIO	IN	TYPE		SIZE	MODEL	INTE	RFACE
4	F0.	DOUN	DIED		62.4	X-	TRACTOR	4	16	20		1						
1	58	ROUN	ID LED	2	63.1	STAIN	ILESS STEE	L 2	20	20							1	
	50	50.11	D. L.E.D.		00.4	X-	TRACTOR	4	16	00	DIOUT	ANICI	U D400.0	VEDLAS	46		1	
2	58	I ROUN	ID LED		63.1	1 . S . A S W.	I FOO OTER			20	RIGHT	IANSU	JL R102 O	VERLAPI	15			

2	56		KOUND	LED		2	03.1	STAINLESS S	STEEL 2	20 20	RIGHT	ANSU	L R 102 OVER	LAP	15				
SUPPLY I	PLENUM INFORMATION											0		- 0		-	2.4		
HOOD	MARK	DOS	TYPE	S	IZE (II	N.)	INSULATED	DAMBER(S)	LED LIGI	HT(S)	TOTAL				C	OLLARS			
NO.	WARK	POS.	THE	L	W	Н	INSULATED	DAMPER(S)	SUPPLIED	QTY	CFM	TYPE	MOUNTING	QTY	W	L DIA.	CFM	S.P.	VEL.
1	58	FRONT	ASP	107	12	10	NO	YES	NO		1440	MUA	FACTORY	2	8	24	720	0.11	540
2	58	FRONT	ASP	119	12	10	NO	YES	NO		1440	MUA	FACTORY	2	8	24	720	0.09	540

HOOD OPTIONS
UL 710 LISTED V

UL 710 LISTED W/ OUT EXHAUST FIRE DAMPER - UL #R25625 BACK INTEGRAL AIR SPACE - 3 IN WIDE


18 IN HIGH CEILING ENCLOSURES - FRONT LEFT RIGHT - FIELD INSTALLED


CONTINUOUS CAPTURE


FACTORY MOUNTED EXHAUST COLLAR(S)
EXHAUST AIR BALANCING BAFFLE(S) - (EABB)


PERFORMANCE ENHANCING LIP (PEL) TECHNOLOGY

STANDING SEAM CONSTRUCTION FOR SUPERIOR STRENGTH

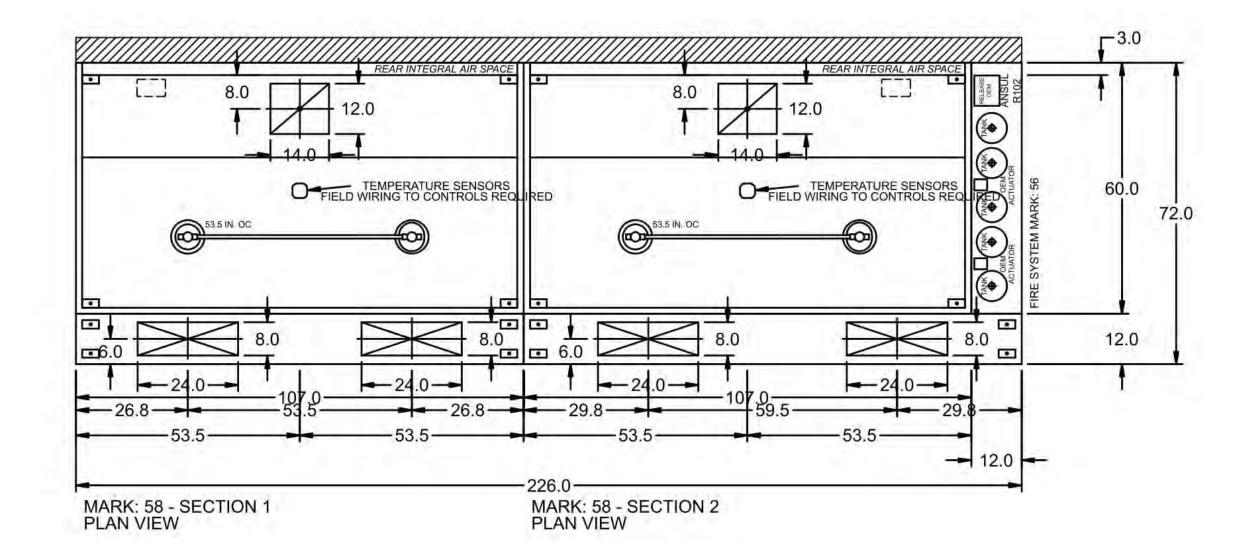

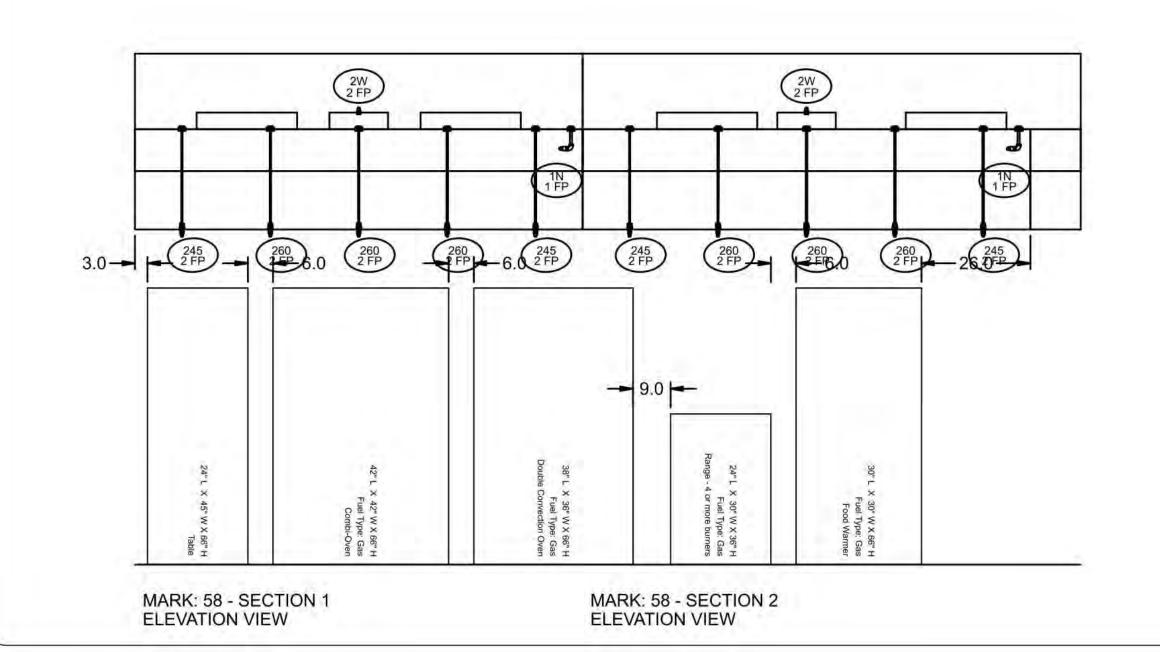

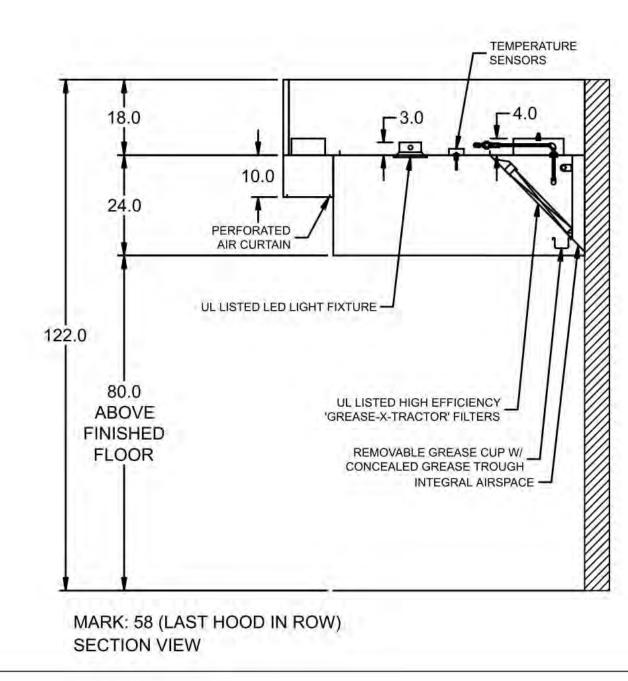

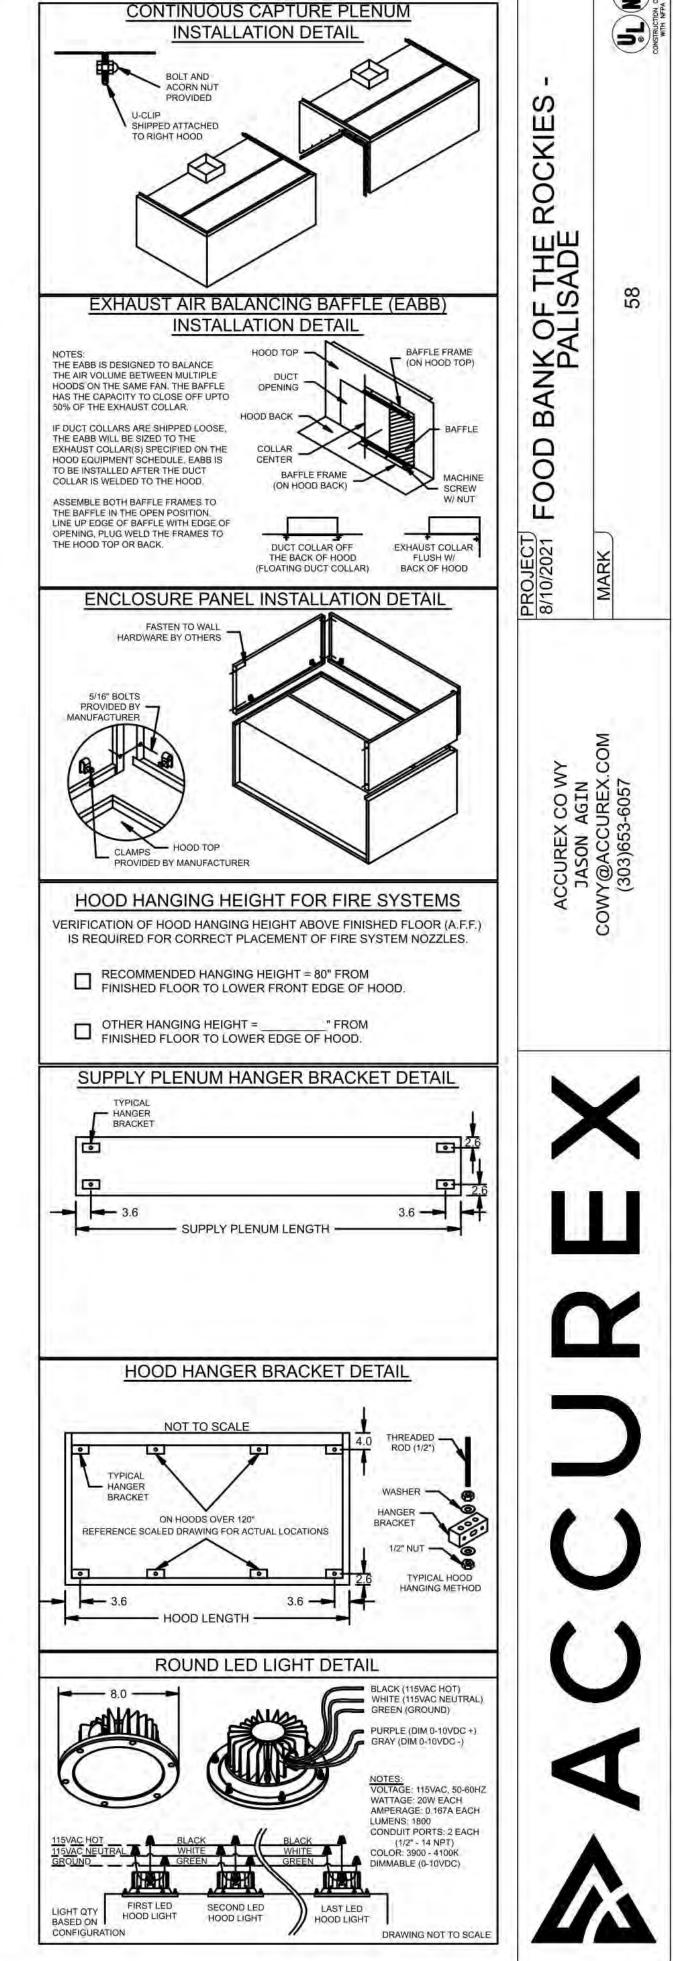

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FOOD BANK OF THE

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HOOD DETAIL

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FS2.2

UNIT MUST BE GROUNDED IN ACCORDANCE L'APPAREIL DOI' WITH N.E.C. POWER MUST BE OFF WHILE CONFORMÉMENT AU	RATED TO 90°C UNLESS SPECIFIED. TORQUE CONTROL & GROUND BLOCKS TO 8 LBS. IN. TORQUE POWER LUGS/SCREWS TO COMPONENT RATINGS LISTED. TORQUE CONTROL BOARD SCREW TERMINALS TO 3.5 LBS. IN. FIELD CONTROL WRING RESISTANCE SHOULD NOT EXCEED 0.75 OHM. SEE IOM FOR ADDITIONAL INFORMATION, OR CALL FACTORY AT 1-800-371-6858. PHASE, 50 -60HZ, 15A RATED TO 90°C UNLESS SPECIFIED. TORQUE CONTROL BOARD SCREW TO COMPONENT RATINGS LISTED. TORQUE CONTROL BOARD SCREW TO COMPONENT RATINGS LISTED. TORQUE CONTROL BOARD SCREW TO COMPONENT RATINGS COSSES/VIS D'ALIMENTATION AUX COUPLES INDIQUÉS POUR LE COMPOSANT. SERRER LES BORNES À VIS DE LA CARTE DE COMMANDE A 3.5 LB-PO. LA RÉSISTANCE DU CÂBLAGE DE COMMANDE LOCAL NE DOIT PAS DÉPASSER O,75 OHM. POUR PLUS D'INFORMATION, CONSULTER O,75 OHM. POUR PLUS D'INFORMATION, CONSULTER ON TORQUE POWER LUGS/SCREWS TO COMPONENT RATINGS (COSSES/VIS D'ALIMENTATION AUX COUPLES INDIQUÉS POUR LE COMPOSANT. SERRER LES BORNES À VIS DE LA CARTE DE COMMANDE A 3.5 LB-PO. LA RÉSISTANCE DU CÂBLAGE DE COMMANDE LOCAL NE DOIT PAS DÉPASSER O,75 OHM. POUR PLUS D'INFORMATION, CONSULTER O,75 OHM. POUR PLUS D'INFORMATION, CONSULTER ON TORQUE POWER LA CARTE DE COMMANDE LOCAL NE DOIT PAS DÉPASSER O,75 OHM. POUR PLUS D'INFORMATION, CONSULTER ON TORQUE POWER LA CARTE DE COMMANDE LOCAL NE DOIT PAS DÉPASSER O,75 OHM. POUR PLUS D'INFORMATION, CONSULTER ON TORQUE POWER LA CARTE DE COMMANDE LOCAL NE DOIT PAS DÉPASSER O,75 OHM. POUR PLUS D'INFORMATION, CONSULTER ON TORQUE POWER LA CARTE DE COMMANDE LOCAL NE DOIT PAS DÉPASSER O,75 OHM. POUR PLUS D'INFORMATION, CONSULTER ON TORQUE POUR LE COMPONENT L'ENTRE LES BORNES DE COMMANDE LOCAL NE DOIT PAS DÉPASSER O,75 OHM. POUR PLUS D'INFORMATION, CONSULTER ON TORQUE POUR L'ENTRE L'ES BORNES DE COMMANDE L'ESTRER LES BORNES DE COMMANDE L'ENTRE L'ES BORNES DE COMMANDE L'ESTRER LES BORNES DE COMMANDE L'ESTRE L'ES BORNES DE COMMANDE L'ESTRE L'ES BORNES DE COMMANDE L'E	G DIAGRAM CODE: WDC# AME: FOOD BANK OF THE ROCKIES - PALISADE EL: XKC-DCV-S-21-4-1-0 AL NUMBER: WDSN#	CABINET DETAILS DRAWING NOT TO SCALE 12 6	ECT FOOD BANK OF THE RC PALISADE
BUILDING BREAKER PANEL 110V-120V / 1PH POWER FOR CONTROLS / LIGHTS (NON SHUNTED 15A BREAKER) OR NO POWER TO PANEL: C TO NO WILL OPEN C TO	CONTROL WRING FOR KITCHEN CONTROLS (WIRING TO BE DONE BY ELECTRICIAN, IF NO CONTROLS CONTRACTOR. USE 18-22GA WIRE UNLESS SPECIFIED.) DRY RUN	MAIN CONTROL PANEL (CONTINUED) MB (MAIN BOARD) FS-C FS-NC TS-1A TS-1B TS-1B TS-2A TS-2B TS-3A TS-3B TS-4A TS-4B MAIN FIRE SUPPRESSION FIRE SYSTEM SWITCH (REMOVE JUMPER IF USED)** WILL BE MOUNTED MET TO FIRE SYSTEM HOOD H1 TEMP SENSOR HOOD MARK: 53 SECTION 1 HOOD H2 TEMP SENSOR HOOD MARK: 53 SECTION 2 HOOD H4 TEMP SENSOR HOOD MARK: 53 SECTION 2 HOOD H4 TEMP SENSOR HOOD MARK: 58 SECTION 2	ZONE # ZONE ROOM TEMP 1 Z1 PRESET JOB NAME: FOOD BANK OF THE ROCI - PALISADE MODEL: XKC-DCV-S-21-4-1-0 SERIAL NUMBER: WDSN# MARK: CP-1 DOC NUMBER: — RE DEFAULT SETTINGS / PARAMÈTRES PAR DÉFAUT FACTORY SETTINGS TYPE: VAV CONFIGURATION HOOD # HOOD HOOD MARK ZONE EXHAUST SUPPLY MB-TEMP SENSORS HCB	ACCUREX CO WY JASON AGIN COWY@ACCUREX.COM MARK
		DI-1A DI-1B DI	1 H1 53 SECTION 1 Z1 E1 S1 TS1 NO 2 H2 58 SECTION 1 Z1 E2 S1 TS2 NO 3 H3 53 SECTION 2 Z1 E1 S1 TS3 NO 4 H4 58 SECTION 2 Z1 E2 S1 TS4 NO SECTION 2 Z1 E2 S1 TS4 NO TS4 NO SECTION 2 Z1 E2 S1 TS4 NO FRIEZE PROTECTION: YES GAS RESET NO FRIEZE PROTECTION: YES SEE JONE CONFIGURATION IN TABLE ON LEFT SUPPLY FAN SETTINGS SEE FAN CONFIGURATION IN TABLE ON LEFT SENSOR SETTINGS SEE FAN CONFIGURATION IN TABLE ON LEFT SENSOR SETTINGS SEE FAN CONFIGURATION IN TABLE ON LEFT SENSOR SETTINGS SEE FAN CONFIGURATION IN TABLE ON LEFT SENSOR SETTINGS SEE FAN CONFIGURATION IN TABLE ON LEFT SENSOR SETTINGS SEE FAN CONFIGURATION IN TABLE ON LEFT SENSOR SETTINGS (HGB) NA GENERAL SETTINGS (HGB) NA GENERAL SETTINGS (HGB) NA GENERAL SETTINGS TIME ZONE: CENTRAL DAYLIGHT (DEFAULT) FIREFAULT SETTINGS EXHAUST DURING FIRE: OFF LIGHTS DURING FIRE: OFF	
*FIRE SYSTEM DRY CONTACT WIRING EXAMPLES SHUNT TRIP APPLIANCE CONTACTORS (BY OTHERS) WIRING EXAMPLE: WIRING EXAMPLE: COMMON NORMALLY OPEN NOT NORMALLY OPEN SHUNT TRIP SHUNT TRIP APPLIANCE CONTACTOR COMMON NORMALLY CLOSED APPLIANCE CONTACTOR COMMON APPLIANCE COMMON NORMALLY CLOSED APPLIANCE COMMON NORMALLY CLOSED APPLIANCE COMMON NEUTRAL SHUNT TRIP APPLIANCE COMMON NEUTRAL COMMON APPLIANCE COMMON NEUTRAL COMMON APPLIANCE COMMON COM		**WHEN FIRE SYSTEM IS ARMED, FS-C TO FS-NC SHOULD HAVE CONTINUITY	2 SUPPLY S1 MAU-1 Z1 2400 4800 NO 5.0	

FANS CONTROLLED

1 3500 2

1 4800 2

ZONE CFM MOTOR HP MOTOR VOLT CYCLE MOTOR PHASE MOTOR STARTER IN PANEL VFD IN PANEL

NO

NO

NO

NO

460 60

60

460

CONTROL INFORMATION

ELECTRICAL CONTROL PACKAGE

LOCATION

SHIP LOOSE ENCLOSURE

MODEL

XKC-DCV-S-21-4-1-0

USER INTERFACE

LOCATION

FACE MOUNT ON CONTROL PACKAGE

TYPE

FULL COLOR TOUCHSCREEN

FAN # TYPE FAN

1 EXHAUST E1

2 SUPPLY S1

FAN MARK

KEF-1

MAU-1

ADD #9 THE KITCHEN HOOD ASSEMBLY, FIRE SUPPRESSION SYSTEM,
CONTROLS AND RELATED ACCESSORIES AS SHOWN OR SPECIFIED
OR REQUIRED FOR COMPLETE AND FUNCTIONAL SYSTEM SHALL BE
PROVIDED (FURNISHED AND INSTALLED) UNDER THIS CONTRACT.

chamberlin

437 Main Street Grand Junction, CO 81501 970.242.6804 chamberlinarchitects.com

FOOD BANK OF THE ROCKIES

698 LONG ACRE DRIVE GRAND JUNCTION, COLORADO

HOOD DETAIL

100% CONSTRUCTION DOCUMENTS

8/25/2021