GLENWOOD SPRINGS WATER FILTER PLANT

BID/PERMIT

ABBREVIATIONS

ROOM

ROOM NAME

CORRIDOR

STORAGE

STYLE

3'-0" 7'-0"

EXTERIOR SWING

MANIFOLD ROOM EXTERIOR SWING

PLANT CONTROL EXTERIOR SWING

EXISTING VIF

100 106 200

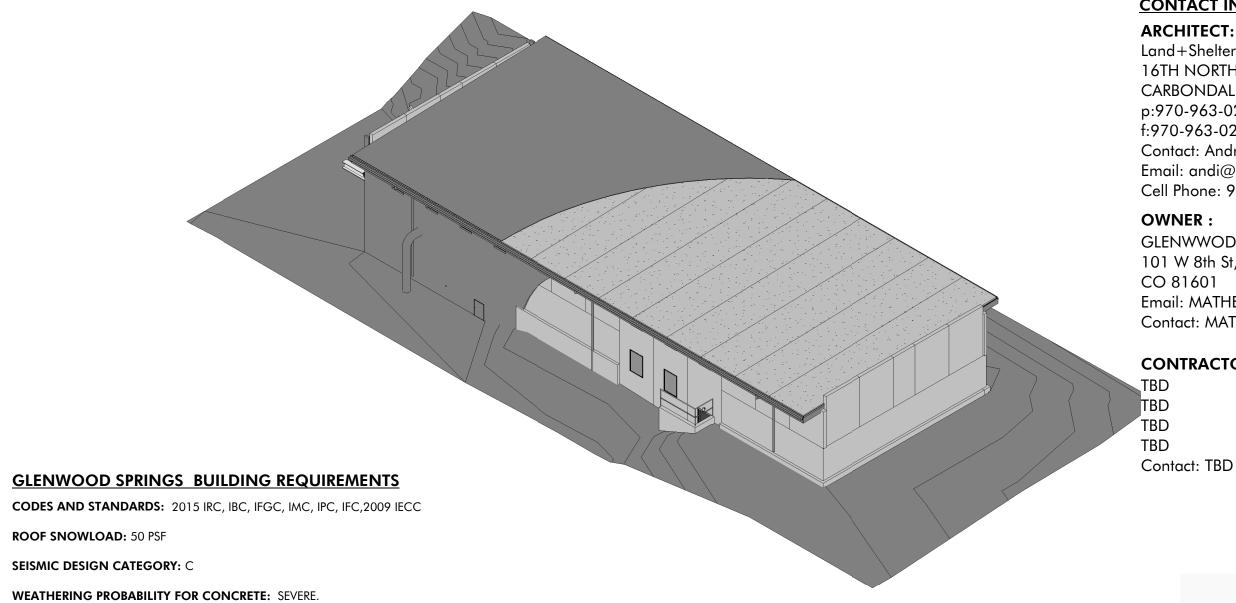
MARK NUMBER

103 | 103

106 | 106

200 200

4.F.F.	ABOVE FINISH FLOOR	INFO.	INFORMATION
ADJ.	ADJUSTABLE	INSUL.	INSULATION
ALT.	ALTERNATE	JST.	JOIST
4.B.	ANCHOR BOLTS	L.L.	LIVE LOAD
Š	AND	LONGINT.	LONGITUDINAL
ARCH.	ARCHITECTURAL	N.I.C.	NOT IN CONTRACT
@	AT	O.C.	ON CENTER
BM.	BEAM	OPP.	OPPOSITE
BM. PKT.	BEAM POCKET	0/	OVER
BRG.	BEARING	PTD.	PAINTED
BLK'G.	BLOCKING	PERF.	PERFORATED
ВОТ.	BOTTOM	PL.	PLATE
3.F.	BOTTOM OF FOOTING	PLY.	PLYWOOD
BLDG.	BUILDING	PROP. LINE	PROPERTY LINE
3.O.	BY OWNER	REINF.	REINFORCEMENT
CAB.	CABINET	RDWD.	REDWOOD
CLG.	CEILING	REQ'D.	REQUIRED
CL.	CENTER LINE	RESIL.	RESILIENT
C.T.	CERAMIC TILE	REV.	REVISED
CLR.	CLEAR	S.M.	SHEET METAL
COL.	COLUMN	SIM.	SIMILAR
CONC.	CONCRETE	S.F. OR SQ. FT.	SQUARE FEET
CONN.	CONNECTION	STD.	STANDARD
CONT.	CONTINUOUS	STL.	STEEL
OTL.	DETAIL	STDS.	STUDS
OBL.	DOUBLE	THK.	THICK
DWL.	DOWEL	TLT.	TOILET
Ē.W.	EACH WAY	T.F.	TOP OF FOOTING
ELEV. OR EL.	ELEVATION	T.P.	TOP OF PLATE
EXIST'G	EXISTING	T.L.	TOP OF LEDGE
EXT.	EXTERIOR	T.W.	TOP OF WALL
=.F.	FINISHED FLOOR	ТОТ.	TOTAL
=.D.	FLOOR DRAIN	T.B.	TOWEL BAR
ELR.	FLOOR	TRANSV.	TRANSVERSE
TG.	FOOTING	TYP.	TYPICAL
FND.	FOUNDATION	U.N.O.	UNLESS NOTED OTHERWISE
GA.	GAUGE	V.I.F.	VERIFY IN FIELD
G.L.	GLU-LAM	VERT.	VERTICAL
G.W.B.	GYPSUM WALL BOARD	V.W.C.	VINYL WALL COVERING
G.S.	GAS STUB	W.C.	WATER CLOSET
∃B.	HOSE BIB	W.H.	WATER HEATER
HT.	HEIGHT	W.P.	WATERPROOF
HK.	HOOK	W.R.	WATER RESISTANT
HORIZ. HYD.	HORIZONTAL	WIN.	WINDOW
ווט.	HYDRANT	W/	WITH
		WD.	WOOD



CONTACT INFORMATION

ARCHITECT: Land+Shelter, Inc. 16TH NORTH 4TH STREET/ PO BOX 550 CARBONDALE, CO 81623 p:970-963-0201 f:970-963-0289 Contact: Andrea Korber

Email: andi@landandshelter.com Cell Phone: 970-366-1582

GLENWWOD SPRINGS WATER DEPARTMENT 101 W 8th St, GLENWWOD SPRINGS, CO 81601 Email: MATHEW.LANGHORST@COGS.US Contact: MATHEW LANGHORST

CONTRACTOR:

DRAWING INDEX

GENERAL: REVISION: A1.0 COVER SHEET - PROJECT INFO./SCHEDULES 1 **ARCHITECTURAL:** A3.3 **ELEVATIONS** A4.0 A4.1 **ELEVATIONS** A7.0 WALL SECTIONS DOOR & ROOF DETAILS

LOCATION MAP

VIF OPENING SIZE TYP. FRAME AGED BRONZE FINISH

NOTICE: DUTY OF COOPERATION Release of these plans contemplates further cooperation

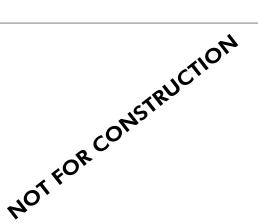
among the owner, his or her contractor, and the architect. Design and construction are complex. Although the architect and his/her consultants have performed their services with due care and diligence, they cannot guarantee perfection. Communication is imperfect and every contingency cannot be anticipated. Any ambiguity or discrepancy discovered by the use of these plans shall be reported immediately to the architect. Failure to notify the architect compounds misunderstanding and increases construction costs. A failure to cooperate by a simple notice to the architect shall relieve the architect from responsibility for all consequences. Changes made from the plans without consent of the architect are unauthorized and shall relieve the designer from all consequences arising out of such changes.

ARCHITECTURE AND PLANNING

16 North 4th Street, Carbondale, CO 81623

t 970.963.0201 info@landandshelter.com

BID/PERMIT JULY 19.2022 Revisions



GLENWOOD SPRINGS WATER FILTER PLANT 81601

> **COVER SHEET - PROJECT** INFO./SCHEDULES

Sheet Number:

PROJECT DESCRIPTION

TERMITE INFESTATION PROBABILITY: NONE TO SLIGHT.

AIR FREEZING INDEX: 2500. ICE SHIELD UNDERLAYMENT REQUIRED.

WIND SPEED: 90MPH

WIND EXPOSURE: B

FROST DEPTH: 36IN.

INSULATION:

MINIMUM R-VALUES: -ROOF R-VALUE 30ci

DECAY PROBABILITY: SLIGHT

WINTER DESIGN TEMPERATURE: -2F

MEAN ANNUAL TEMPERATURE: 48F

CLIMATE ZONE: 5B (GARFIELD COUNTY)

-WINDOWS/DOORS U=.37, TBL 402.1.1, 2021 IECC.

PROJECT SCOPE: INCLUDES REMOVING EXISTING EXTERIOR SPRAY FOAM SYSTEM ON ROOF AND EXTERIOR WALL SURFACES. RE-ROOF INCLUDES TPO, HD BOARD AND REQUIRED INSULATION. ALL EXTERIOR WALLS TO RECEIVE EXTERIOR INSULATION AND METAL WALL PANEL CLADDING. EXTERIOR DOORS AND WINDOWS TO BE REPLACED.

NOTES VIF VERIFY OPENING SIZE TYP. FRAME AND DOOR PAINTED TO MATCH WINDOW/FASCIA AGED BRONZE.INSULATED DOOR VIF VERIFY OPENING SIZE AND COORDIANTE FINAL SIZE. AGED BRONZE FINISH
WINDOW/FASCIA AGED BRONZE.INSULATED DOOR
VIF VERIFY OPENING SIZE AND COORDIANTE FINAL SIZE. AGED BRONZE FINISH
MATCH WINDOW FRAMES
VIF VERIFY OPENING SIZE TYP. FRAME AND DOOR PAINTED TO MATCH WINDOW/FASCIA AGED BRONZE.INSULATED DOOR
VIF VERIFY OPENING SIZE TYP. FRAME AND DOOR PAINTED TO MATCH WINDOW/FASCIA AGED BRONZE.INSULATED DOOR

)			

VIF		
	C TO COORDINATE	DOOR HARDWARE SET #1 • 3 HINGES - BB1199, 4 1/2 4 1/2 • 1 LOCKSET - 3553 LEVER-ENTRY • 1 CLOSER - 5100 ALM • 1 KICKPLATE (PUSH SIDE) 190S 10 • 1 WALL STOP 232 W/236W (AS R • 1 DOOR SWEEP 750S N X LAR, CI • 1 THRESHOLD 413S X LAR, MIL • 1 LATCH GUARD 341C-US32D • DOOR SILENCER 307D. GRAY (AS
	1 (1)	

DOOR DOOR DOOR

DOOR SCHEDULE

WIDTH | HEIGHT | GLAZING | RATING | HARDWARE | SILL | JAMB | HEAD

GC TO COORDIANTE

RE: SCHEDULE	y	RE: SCHEDULE
	RE: SCHEDULE	
$\langle w_1 \rangle$		$\langle w_2 \rangle$

49 W1 OFFICE

	GC TO COORDINATE	DOOR HARDWARE SET #1 • 3 HINGES - BB1199, 4 1/2 4 1/2 NRP, US26D • 1 LOCKSET - 3553 LEVER-ENTRY • 1 CLOSER - 5100 ALM • 1 KICKPLATE (PUSH SIDE) 190S 10"X32" US32D • 1 WALL STOP 232 W/236W (AS REQ.) US32D • 1 DOOR SWEEP 750S N X LAR, CLR • 1 THRESHOLD 413S X LAR, MIL • 1 LATCH GUARD 341C-US32D • DOOR SILENCER 307D. GRAY (AS REQ.) HOLLOW METAL DOOR AND FRAME: • 16 GAUGE WELDED FRAME • 7 GAUGE HINGE REINFORCEMENT • 12 GAUGE STRIKE PROTECTION • 16 GAUGE DOOR LEAF • INSULATED CORE	
103		FACTORY PRIMED FOR PAINT	

202

2'-9"

4'-1"

WINDOW SCHEDULE FRAME SIZE ROOM WINDOW WINDOW WINDOW NUMBER FRAME WIDTH FRAME HEIGHT OPERATION VIF OPENING SIZE TYP. FRAME AGED BRONZE FINISH 37 W1 OFFICE 2'-9" 4'-1" BOTTOM VIF OPENING SIZE TYP. FRAME AGED BRONZE FINISH 38 W1 OFFICE 2'-9" BOTTOM VIF OPENING SIZE TYP. FRAME AGED BRONZE FINISH 39 W1 OFFICE VIF OPENING SIZE TYP. FRAME AGED BRONZE FINISH 40 W1 OFFICE воттом 41 W4 OFFICE BOTTOM 42 W2 MANIFOLD FIXED 43 W2 FIXED

BOTTOM

VIF OPENING SIZE TYP. FRAME AGED BRONZE FINISH FIXED 44 W2 MANIFOLD VIF OPENING SIZE TYP. FRAME AGED BRONZE FINISH ROOM 45 W2 MANIFOLD VIF OPENING SIZE TYP. FRAME AGED BRONZE FINISH ROOM 46 W1 OFFICE VIF OPENING SIZE TYP. FRAME AGED BRONZE FINISH 2'-9" BOTTOM VIF OPENING SIZE TYP. FRAME AGED BRONZE FINISH 47 W1 OFFICE 202 BOTTOM VIF OPENING SIZE TYP. FRAME AGED BRONZE FINISH

PROJECT LOCATION

- GENERAL NOTES:

 1. ALL DIMENSIONS ARE TO FACE OF FRAMING UNLESS NOTED OTHERWISE 2. SNOW BREAKS SHOWN FOR GENERAL DESIGN INTENT. VERIFY FINAL PLACEMENT W/ MFR AND ARCH.
- 3. PROVIDE HEAT TAPE @ GUTTER, DOWNSPOUTS, & EAVES AS NECESSARY. 4. GUTTERS AND DOWNSPOTS AT EAVES, DOWNSPOUTS AS NEEDED. DOWNSPOUTS SHOWN ARE DIAGRAMTIC FOR PRICING. FINAL LOCATIONS TBD. COORDINATE FINAL DOWNSPOUT LOCATION WITH ARCHITECT.

MATERIAL LEGEND

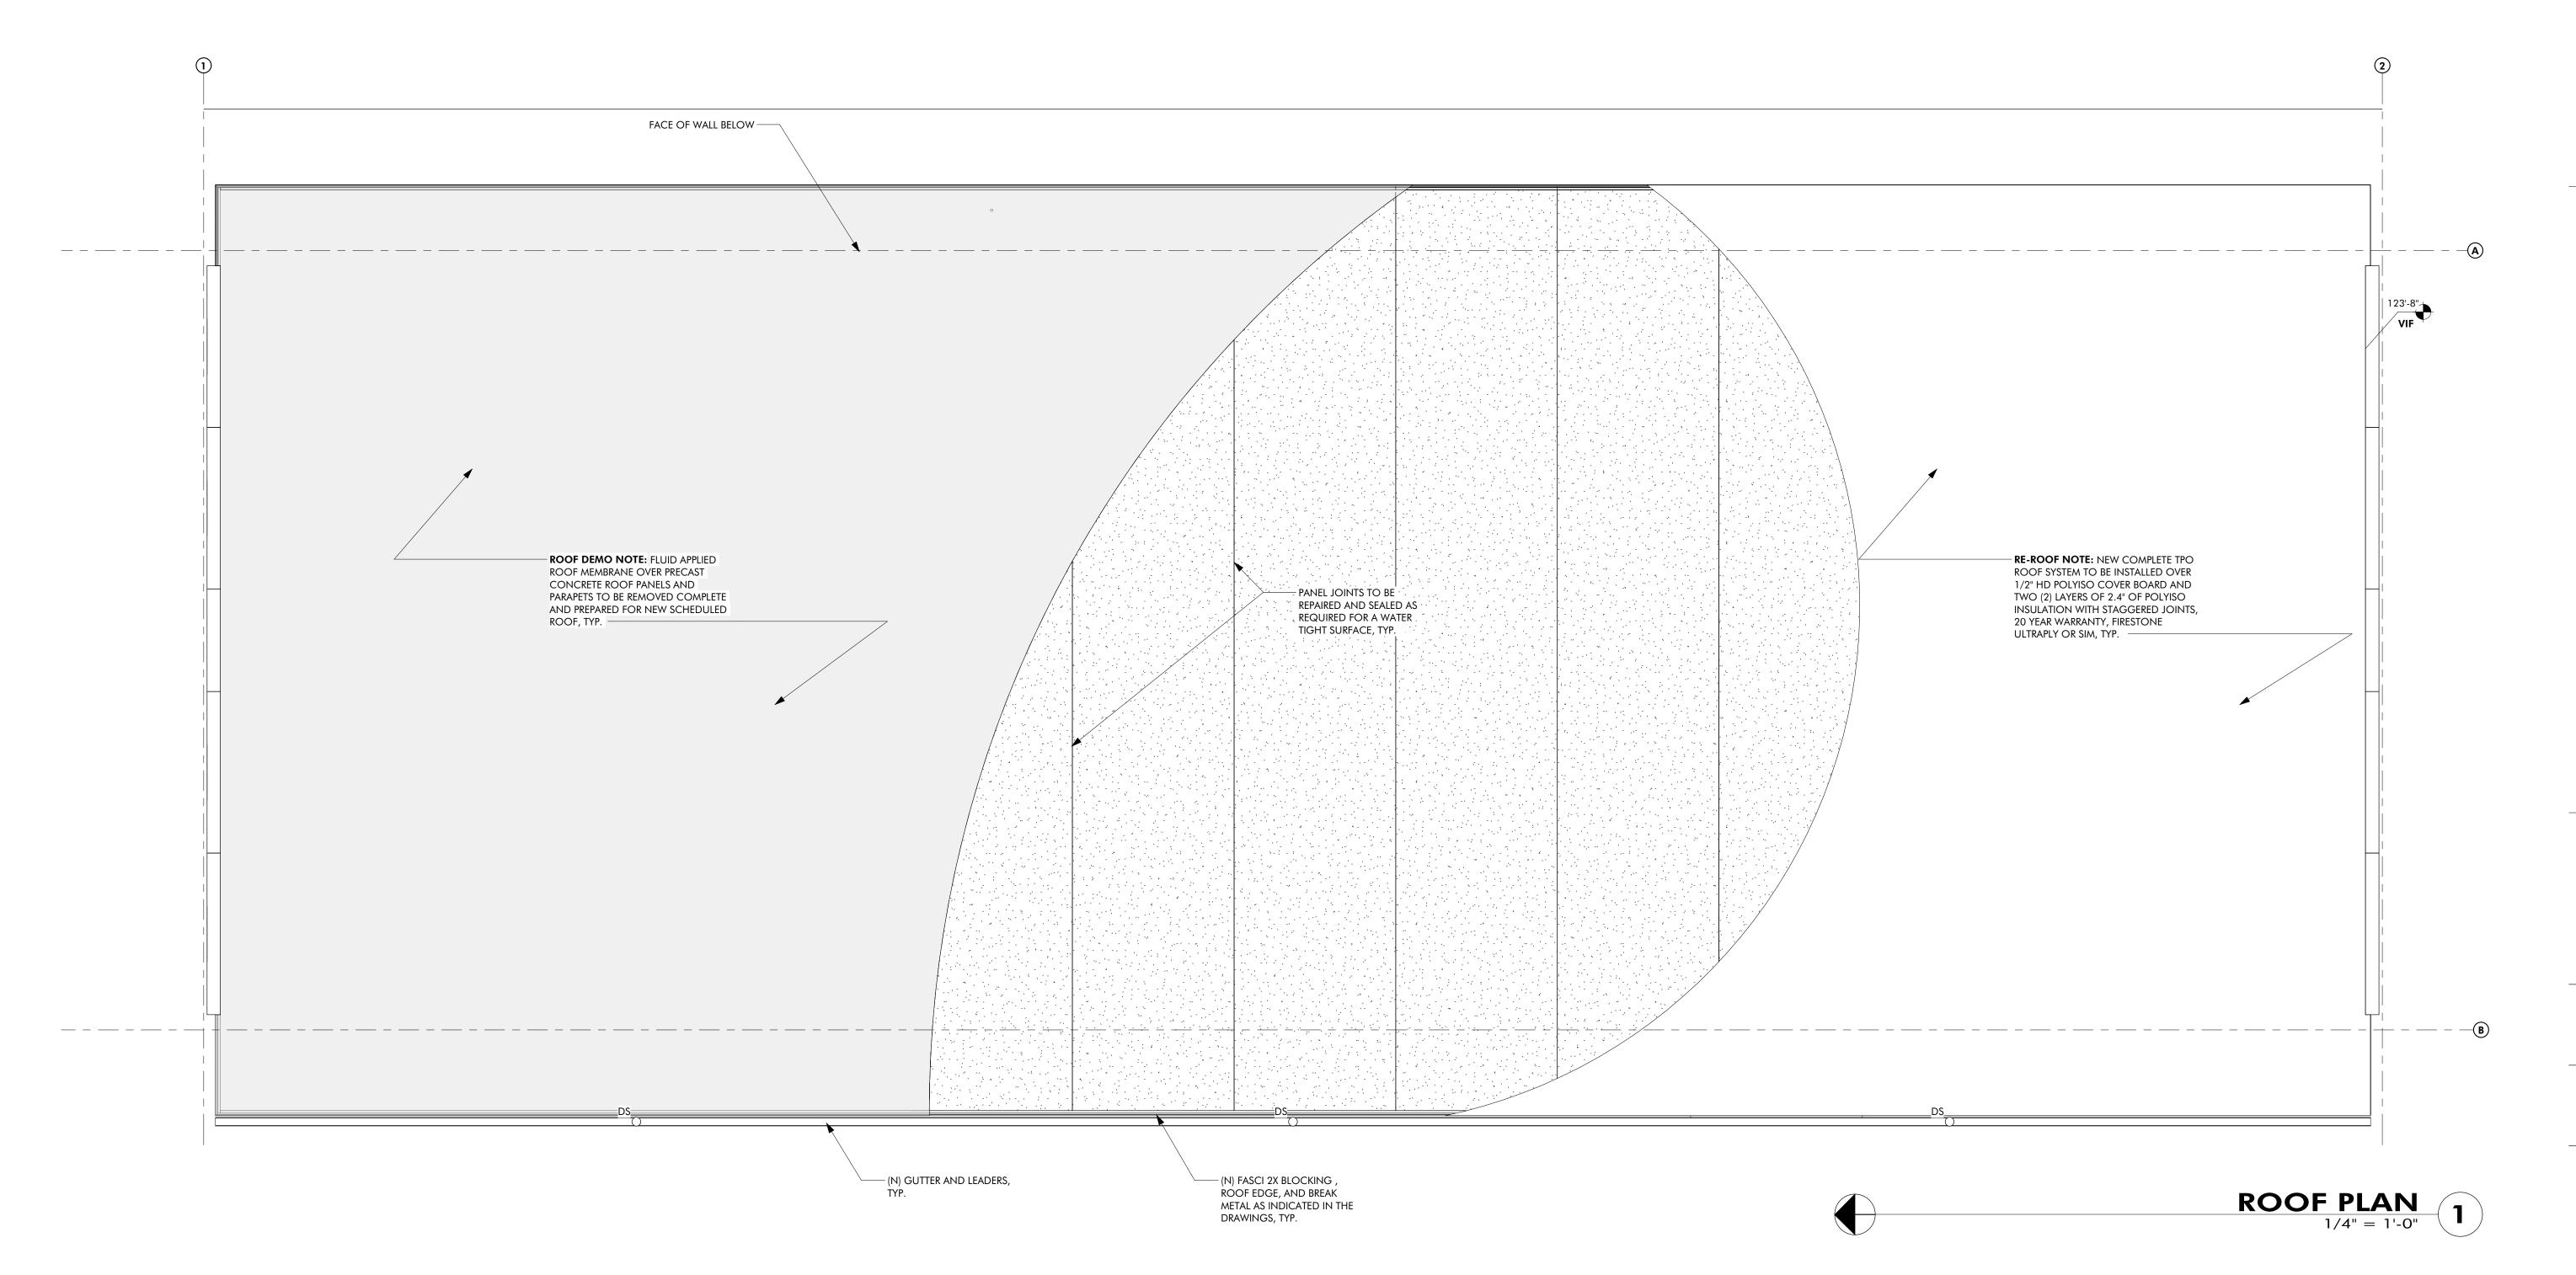
KEY:



ON ROOF

(E) EXISTING SPRAY (N) 60 MIL WHITE TPO ROOF

> GENERAL NOTE: GC TO MAINTAIN 12'-0" CLEAR ZONE FROM FACE OF BUILDING ON ALL FOUR (4) SIDES DURING CONSTRUCTION FOR CLEAR ACCESS. THIS STRUCTURE WILL NOT STOP ACTIVITYS DURING CONSTRUCTION. ALL CUTTING AND SUCH ACTIVITIES ARE TO BE OUTSIDE THIS CLEAR ZONE.





NOTICE: DUTY OF COOPERATION

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GLENW

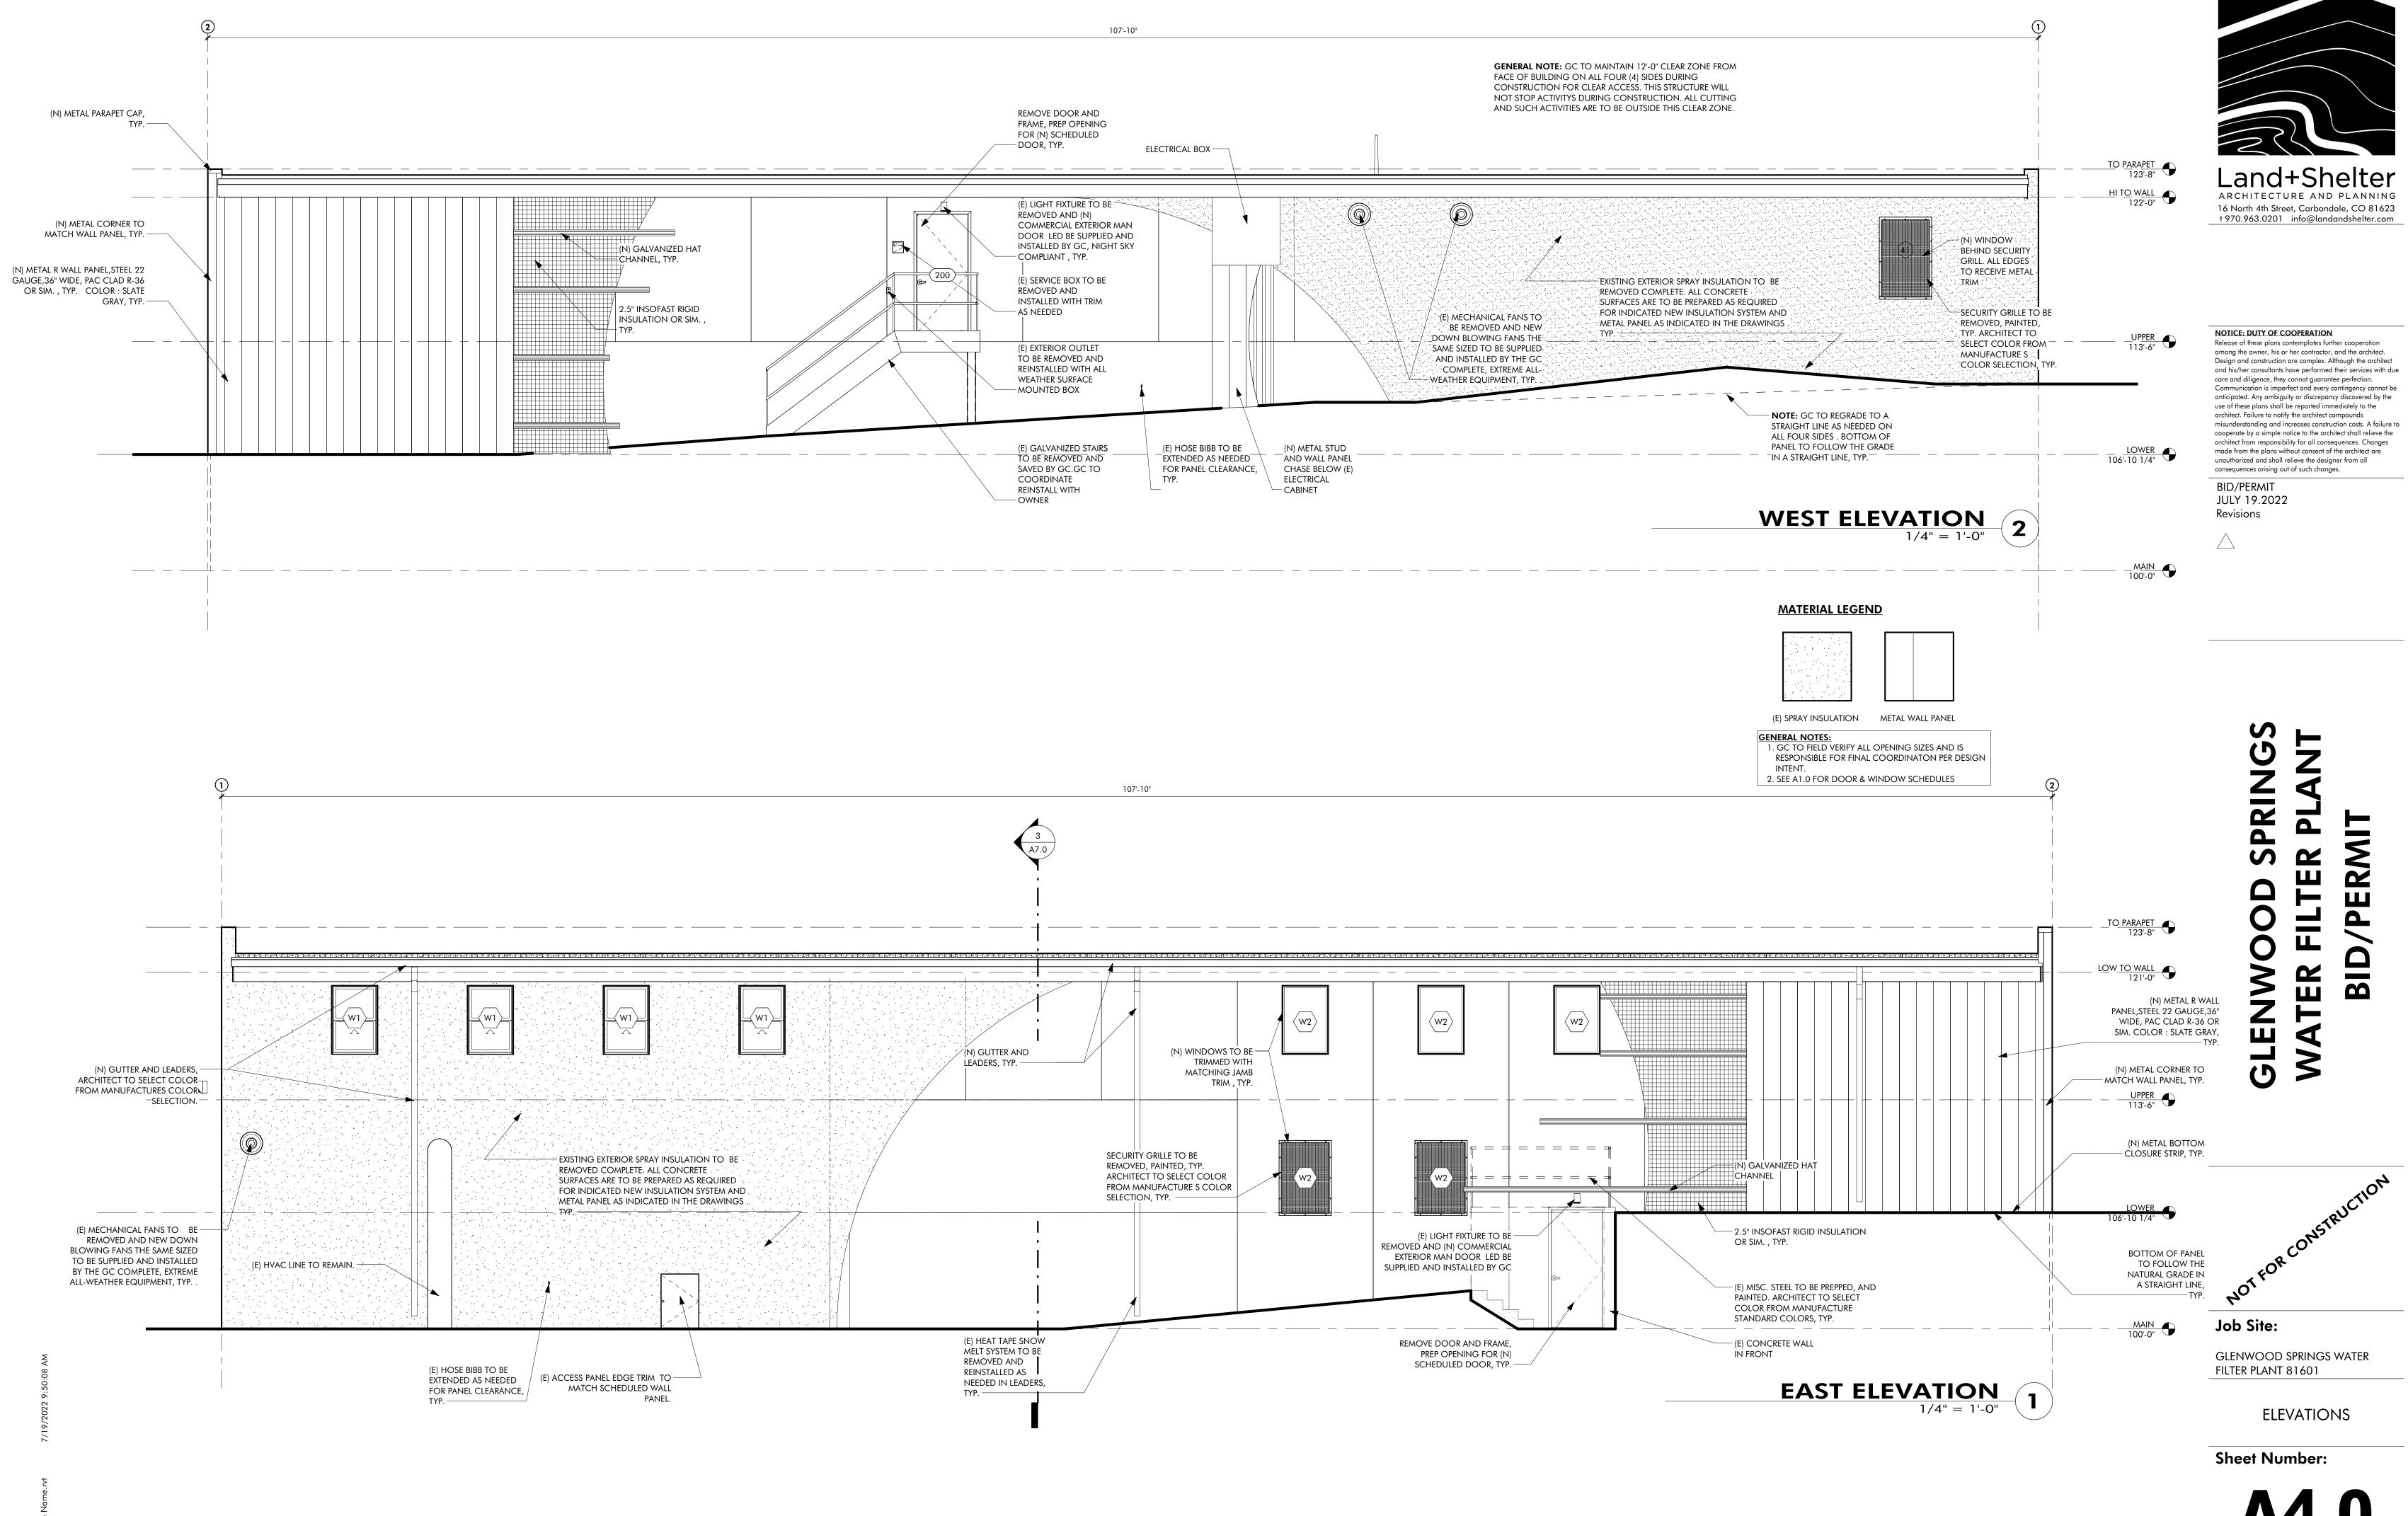


Job Site:

GLENWOOD SPRINGS WATER FILTER PLANT 81601

ROOF PLAN

Sheet Number:



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ELEVATIONS

Sheet Number:

BE REMOVED

- (E) SERVICE BOX TO—— (E) SERVICE BOX TO

BE REMOVED AND

REINSTALLED WITH

(E) HOSE BIBB TO BE

EXTENDED AS NEEDED

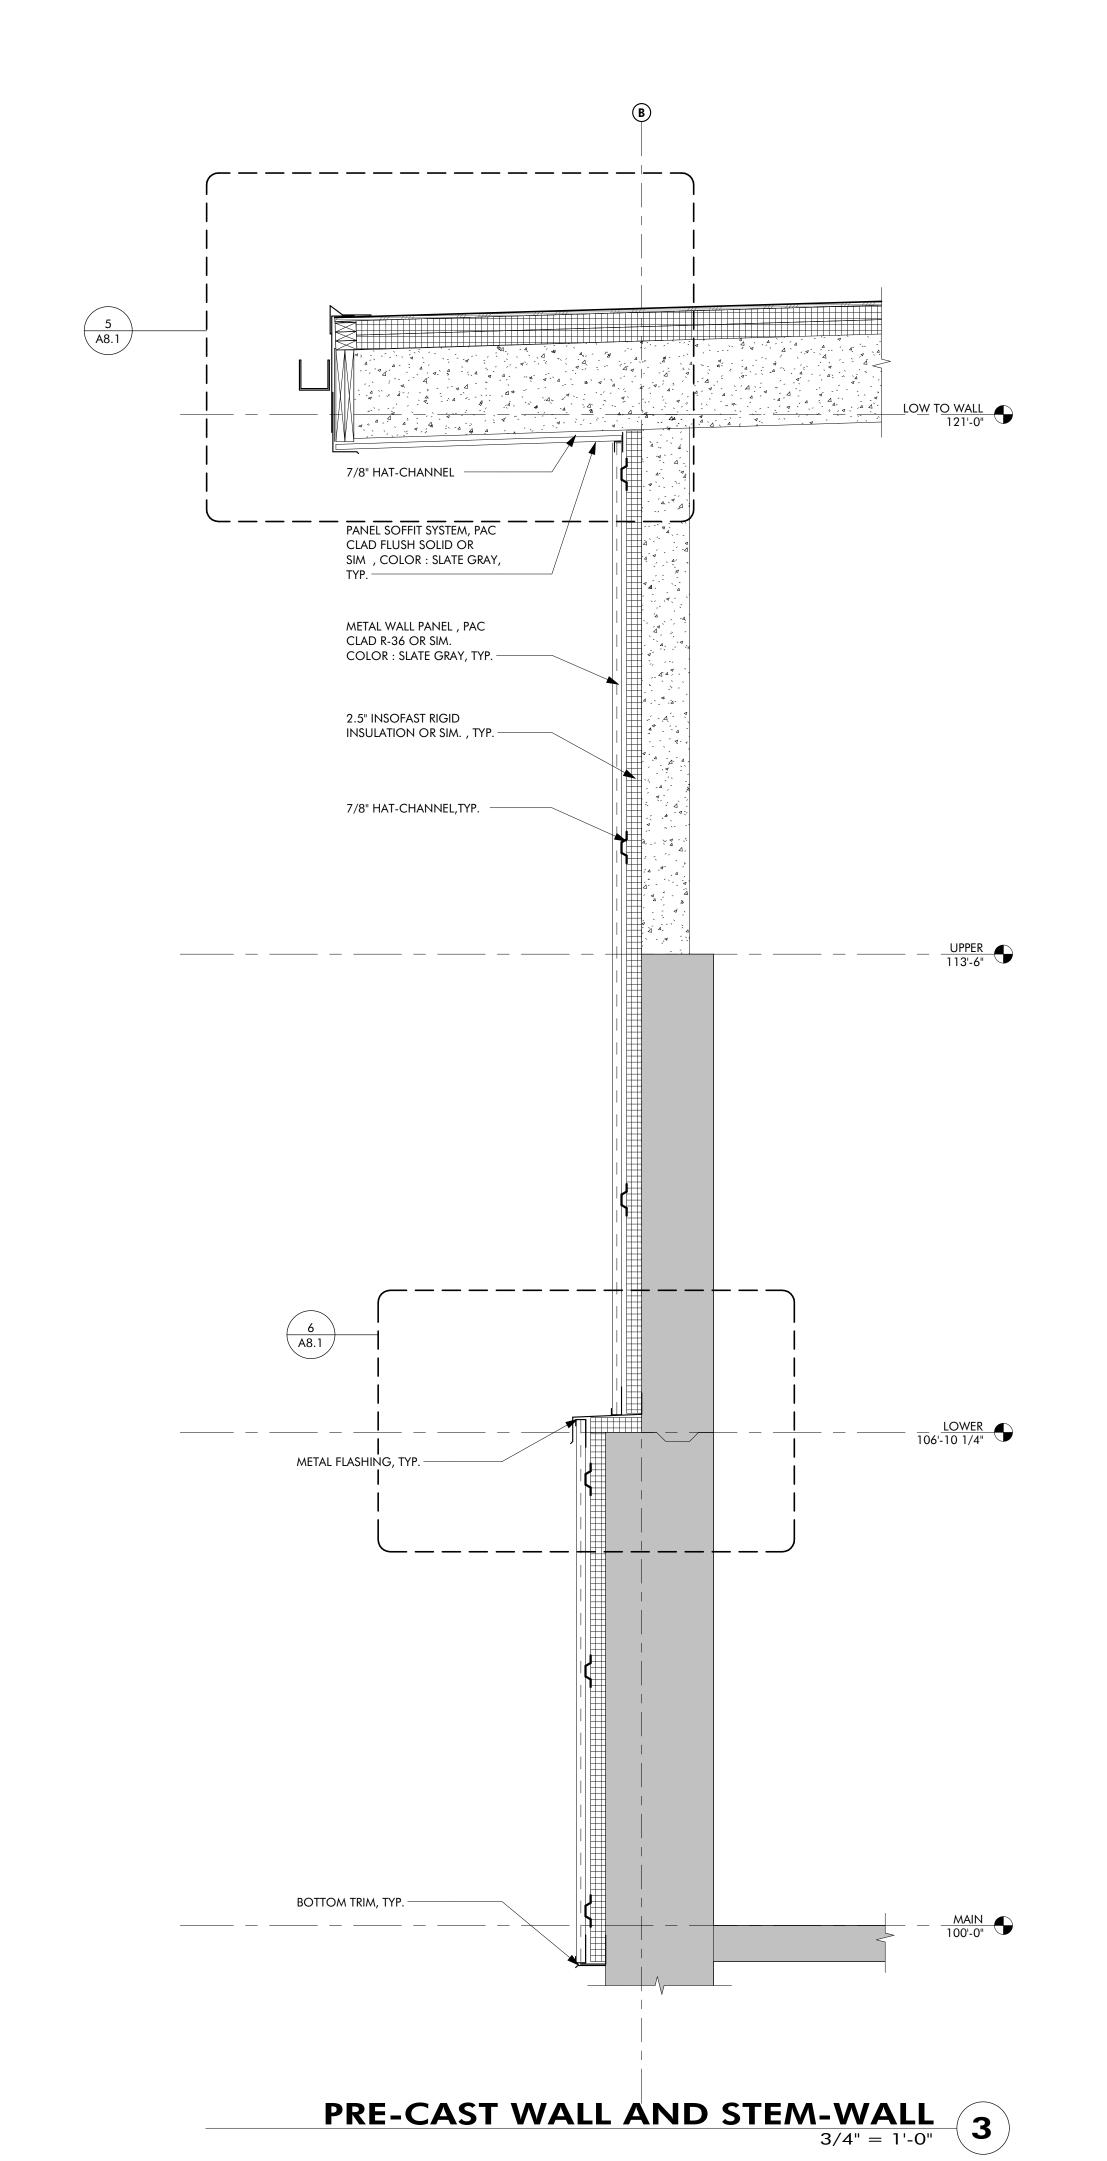
FOR PANEL CLEARANCE, TYP.

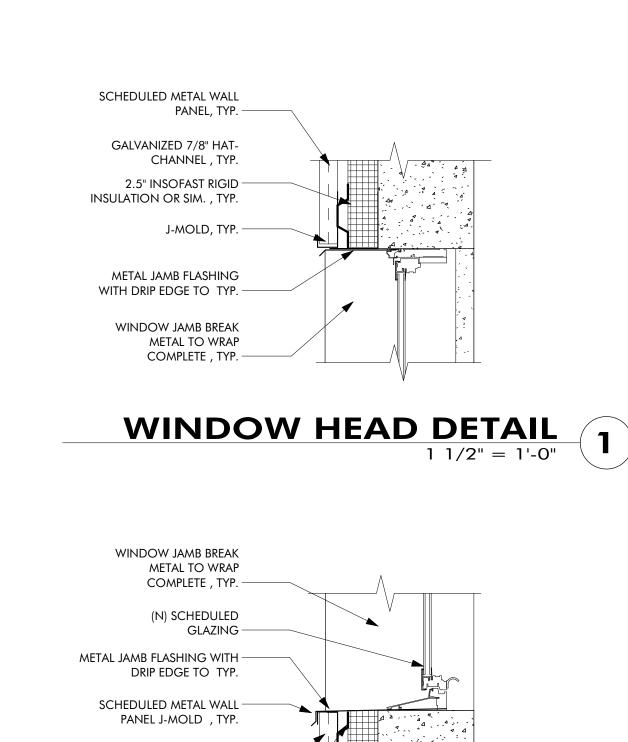
(E) SODIUM HYDROXIDE LOADING VALVE TO BE EXTENDED AS NEEDED FOR NEW METAL WALL

PANEL INSTALLATION, GC TO COORDINATE

WITH OWNER, TYP.

COMPLETE. TYP.





WINDOW SILL DETAIL
1 1/2" = 1'-0"
2

SCHEDULED METAL WALL -

2.5" INSOFAST RIGID – INSULATION OR SIM. , TYP.

GALVANIZED HAT-CHANNEL , TYP.

PANEL, TYP.



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TER FILTER PLANT BID/PERMIT



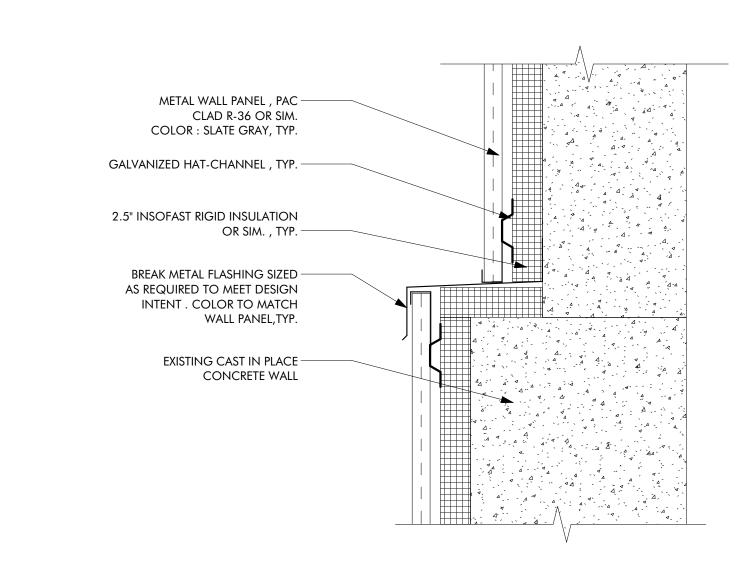
Job Site:

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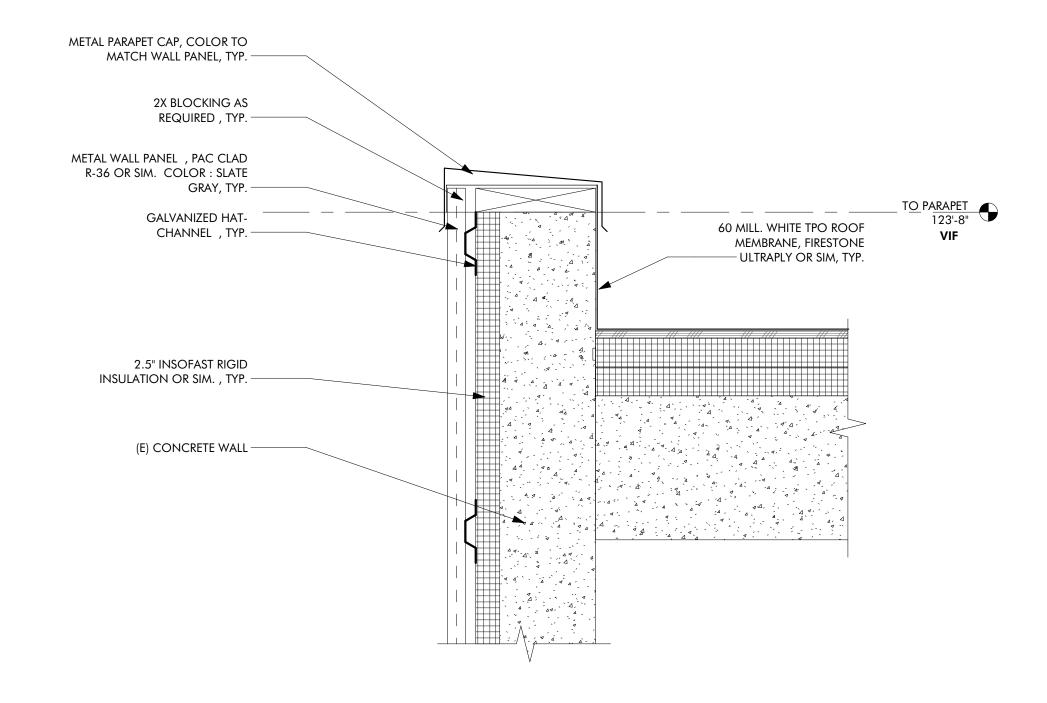
WALL SECTIONS

Sheet Number:

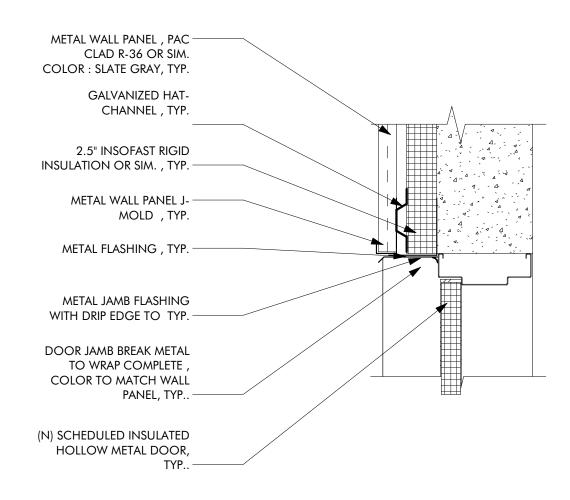
A7.0




STEM-WALL CONNECTION DETAIL
1 1/2" = 1'-0"
6



PARAPET TO ROOF DETAIL 1 1/2" = 1'-0"



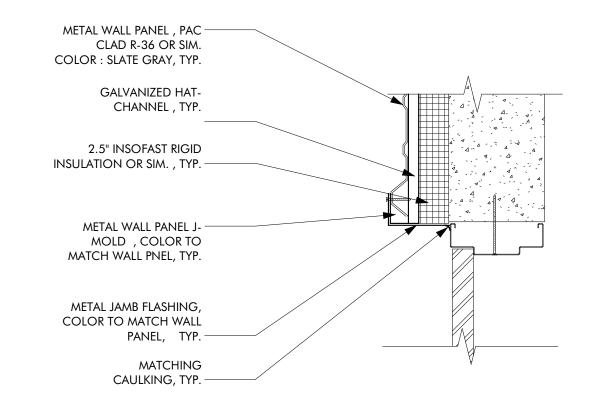HOLLOW METAL DOOR HEAD DETAIL 1 1/2" = 1'-0" 3



HM DOOR JAMB DETAIL
1 1/2" = 1'-0"




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DOOR & ROOF DETAILS

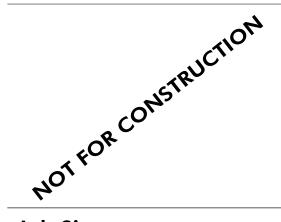Sheet Number: